



HOWARD COUNTY PUBLIC SCHOOL SYSTEM

CAFETERIA HVAC UNIT CONVERSIONS HCPSS BID NO. 123.23.B3

CONSTRUCTION DOCUMENTS MAY 25, 2023

	DRAWII	NG IND	EX
G001	GENERAL COVER SHEET	M701	AUTOMATIC CONTROLS
G002	KEY PLANS	M702	AUTOMATIC CONTROLS
G003	KEY PLANS	M703	AUTOMATIC CONTROLS
		M704	AUTOMATIC CONTROLS
M001	MECHANICAL COVER SHEET	M705	AUTOMATIC CONTROLS
M101	DAYTON OAKS ES - MECHANICAL WORK	M706	AUTOMATIC CONTROLS
M102	ELKRIDGE LANDING MS - MECHANICAL WORK	M707	AUTOMATIC CONTROLS
M103	FULTON ES - MECHANICAL WORK	M708	AUTOMATIC CONTROLS
M104	GLENELG HS - MECHANICAL WORK	M801	MECHANICAL SCHEDULES
M105	GORMAN CROSSING ES - MECHANICAL WORK		
M106	HARPERS CHOICE MS - MECHANICAL WORK	E001	ELECTRICAL COVER SHEET
M107	HOLLIFIELD STATION ES - MECHANICAL WORK	E101	ELKRIDGE LANDING MS - ELECTRICAL WORK
M108	MAYFIELD WOODS MS - MECHANICAL WORK	E102	FULTON ES - ELECTRICAL WORK
M109	OAKLAND MILLS HS - MECHANICAL WORK	E103	GLENELG HS - ELECTRICAL WORK
M110	RIVER HILL HS - MECHANICAL WORK	E104	HARPERS CHOICE MS - ELECTRICAL WORK
M111	VETERANS ES - MECHANICAL WORK	E105	HOLLIFIELD STATION ES - ELECTRICAL WORK
M201	EXISTING AIRFLOW PLANS	E106	MAYFIELD WOODS MS - ELECTRICAL WORK
M202	EXISTING AIRFLOW PLANS	E107	OAKLAND MILLS HS - ELECTRICAL WORK
M203	EXISTING AIRFLOW PLANS	E108	RIVER HILL HS - ELECTRICAL WORK
M501	MECHANICAL DETAILS		

APPLICABLE CODES AND STANDARDS

IBC 2021. INTERNATIONAL BUILDING CODE.

IECC 2021. INTERNATIONAL ENERGY CONSERVATION CODE.

IMC 2021. INTERNATIONAL MECHANICAL CODE.

NFPA 70, 2020. NATIONAL ELECTRICAL CODE.

VETERANS ELEMENTARY SCHOOL - ELLICOTT CITY, MD

SCHOOLS IN PROJECT

DAYTON OAKS ELEMENTARY SCHOOL - DAYTON, MD

ELKRIDGE LANDING MIDDLE SCHOOL - ELKRIDGE, MD

FULTON ELEMENTARY SCHOOL - FULTON, MD

GLENELG HIGH SCHOOL - GLENELG, MD

GORMAN CROSSING ELEMENTARY SCHOOL - LAUREL, MD

HARPERS CHOICE MIDDLE SCHOOL - COLUMBIA, MD

HOLLIFIELD STATION ELEMENTARY SCHOOL - ELLICOTT CITY, MD

MAYFIELD WOODS MIDDLE SCHOOL - ELKRIDGE, MD

OAKLAND MILLS HIGH SCHOOL - COLUMBIA, MD

RIVER HILL HIGH SCHOOL - CLARKSVILLE, MD



HENRY ADAMS

MECHANICAL ELECTRICAL & PLUMBING ENGINEERS

MEP ENGINEERING
HENRY ADAMS,LLC
600 BALTIMORE AVENUE
SUITE 400
BALTIMORE, MD 21204
(410) 296-6500

PROJECT

HOWARD COUNTY PUBLIC SCHOOLS

CAFETERIA HVAC UNIT CONVERSIONS

CONSTRUCTION DOCUMENTS 05/25/2023

SEAL

PROFESSIONAL CERTIFICATION: I HEREBY CERTIFY THAT THESE DOCUMENTS WERE PREPARED OR APPROVED BY ME, AND THAT I AM A DULY LICENSED PROFESSIONAL ENGINEER UNDER THE LAWS OF THE STATE OF MARYLAND.

LICENSE NO: 37247

EXPIRATION DATE: 01/09/2024

NO.	DESCRIPTION	DATE


KEY PLAN


GENERAL COVER SHEET

ROJECT NUMBER	PO-10028674
ATE	05/25/2023
RAWN BY	BMB
HECKED BY	SRH


001

	SCOPE SUMMARY								
UNIT NO	LOCATION	PACKAGED UNIT - SINGLE POINT POWER CONNECTION	SA FAN	RA FAN	EA FAN	NEW VFD'S	ELECTRIC REHEAT COIL	HOT WATER REHEAT COIL	NOTES
AHU-5	DAYTON OAKS ES	NO	YES	YES, W/EX VFD	NO	NO	NO	YES	
AHU-5	ELKRIDGE LANDING MS	NO	YES	NO	NO	YES	NO	YES	
RTU-3	FULTON ES	NO	YES	YES	NO	YES	NO	YES	
AHU-2	GLENELG HS	NO	YES	NO	NO	YES	YES	NO	
ACU-3	GORMAN CROSSING ES	YES	YES	NO	YES, W/EX VFD	NO	NO	YES, EX	
AHU-4	HARPER'S CHOICE ES	NO	YES	NO	NO	YES	YES	NO	
RF-4	HARPER'S CHOICE ES	NO	NO	YES	NO	YES	N/A	N/A	
AHU-3	HOLLIFIELD STATION ES	NO	YES	YES	NO	YES	NO	YES	
ACU-2	HOLLIFIELD STATION ES	YES	YES	NO	YES, W/EX VFD	NO	NO	YES, EX	
AHU-5	MAYFIELD WOODS MS	NO	YES	NO	NO	YES	NO	YES	
AHU-4	OAKLAND MILLS HS	NO	YES	NO	NO	YES	NO	YES	
AHU-12	RIVER HILL HS	NO	YES	YES	NO	YES	NO	YES	
AHU-5	VETERANS ES	NO	YES	YES, W/EX VFD	NO	NO	NO	YES	

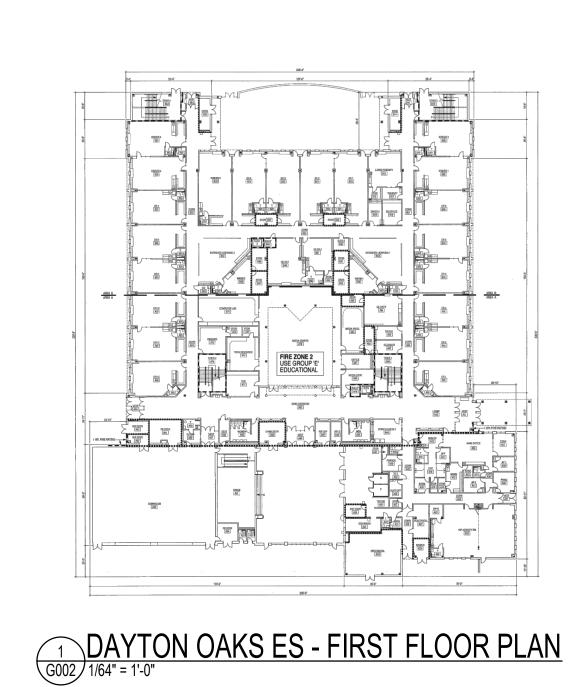

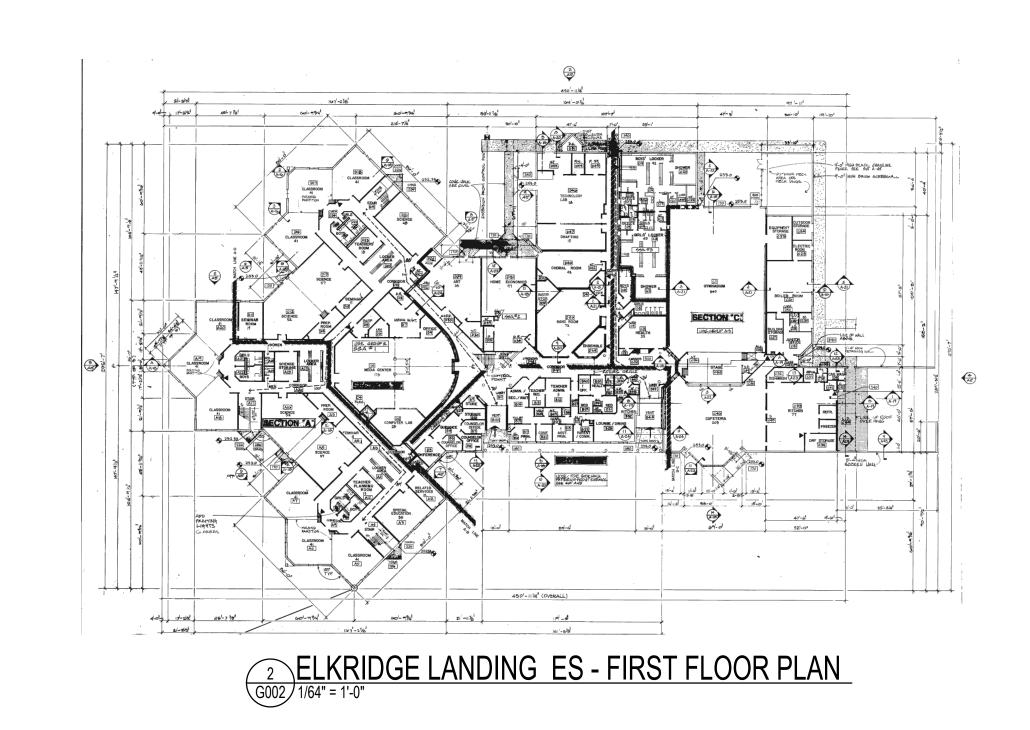




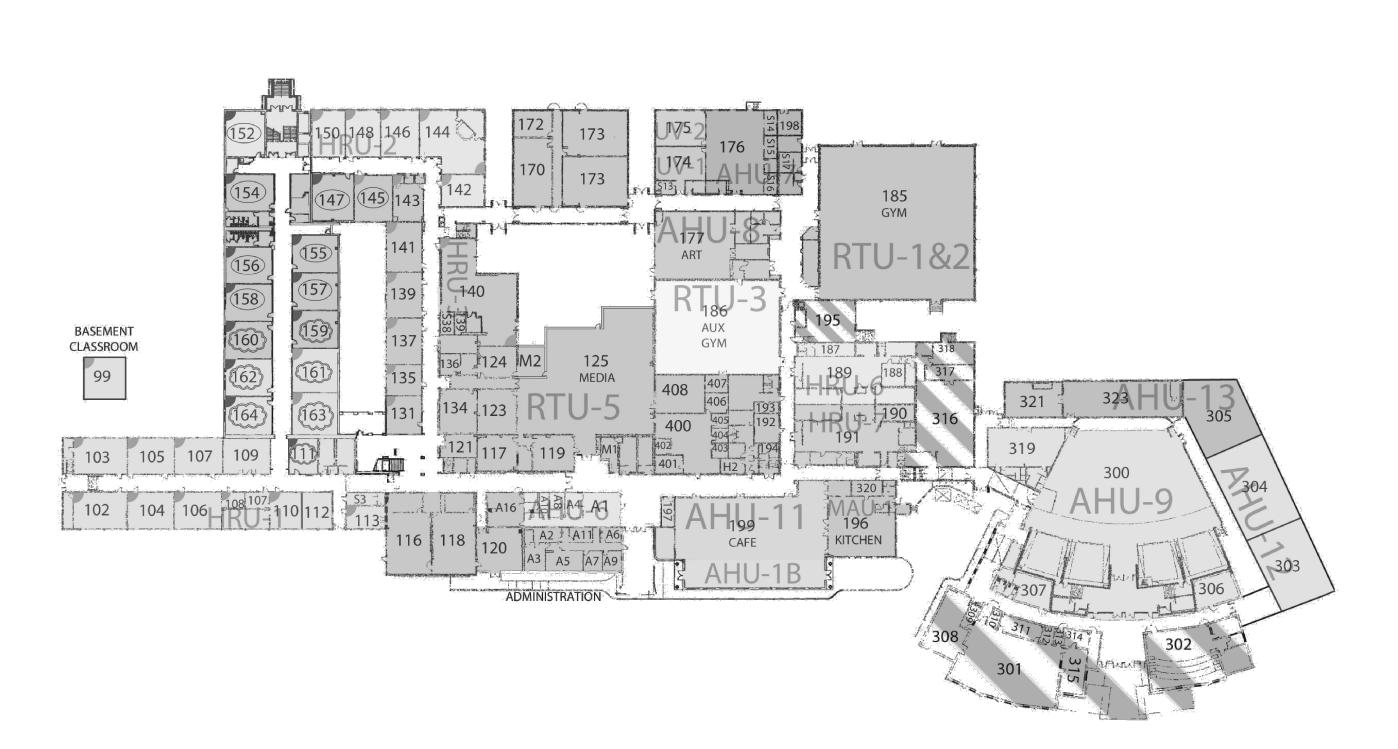

GLENELG ES - FIRST FLOOR PLAN

4
G002 1/64" = 1'-0"

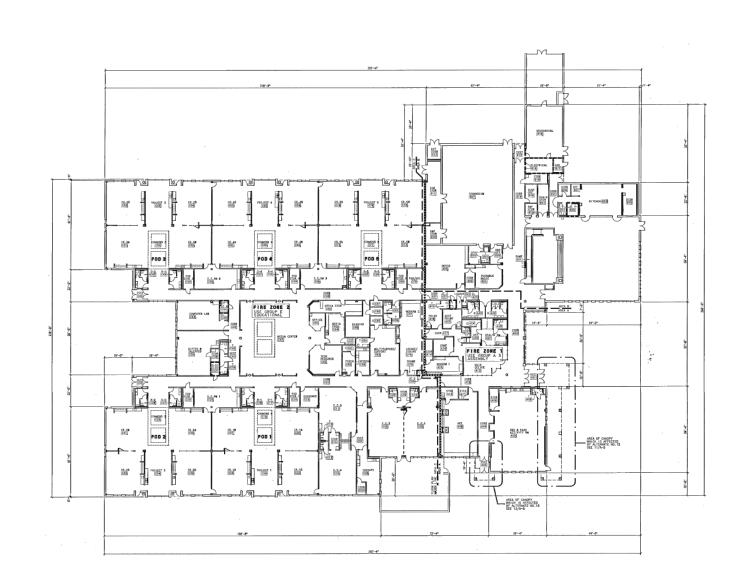

GORMAN CROSSING ES - FIRST FLOOR PLAN

5 G002 1/64" = 1'-0"



HENRY ADAMS

Consulting Engineers

MECHANICAL ELECTRICAL & PLUMBING ENGINEERS

MEP ENGINEERING
HENRY ADAMS,LLC
600 BALTIMORE AVENUE
SUITE 400
BALTIMORE, MD 21204
(410) 296-6500

PROJECT

HOWARD COUNTY PUBLIC SCHOOLS

CAFETERIA HVAC UNIT CONVERSIONS

CONSTRUCTION DOCUMENTS 05/25/2023

SEAL

PROFESSIONAL CERTIFICATION: I HEREBY CERTIFY THAT THESE DOCUMENTS WERE PREPARED OR APPROVED BY ME, AND THAT I AM A DULY LICENSED PROFESSIONAL ENGINEER UNDER THE LAWS OF THE STATE OF MARYLAND.

LICENSE NO: 37247

EXPIRATION DATE: 01/09/2024

NO.	DESCRIPTION	DATE


KEY PLAN


KEY PLANS

PROJECT NUMBER	PO-10028674
DATE	05/25/2023
DRAWN BY	BMB
CHECKED BY	SRH

G002



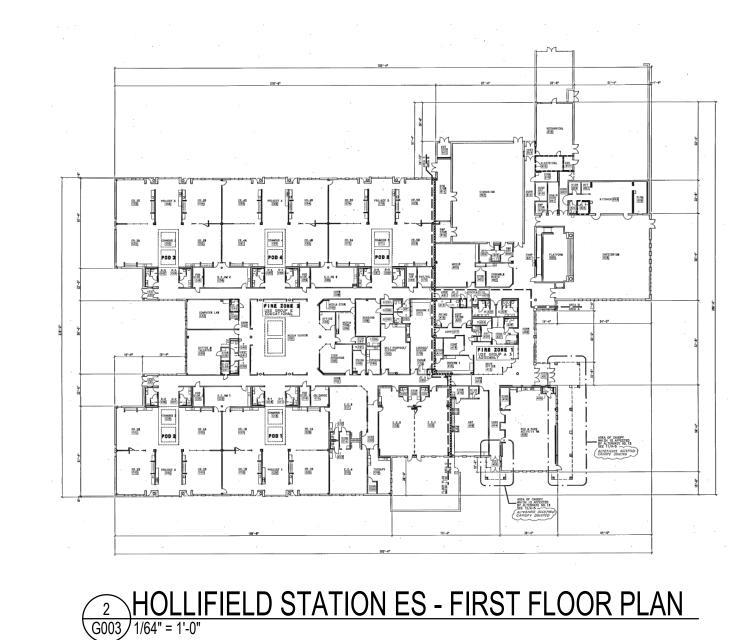


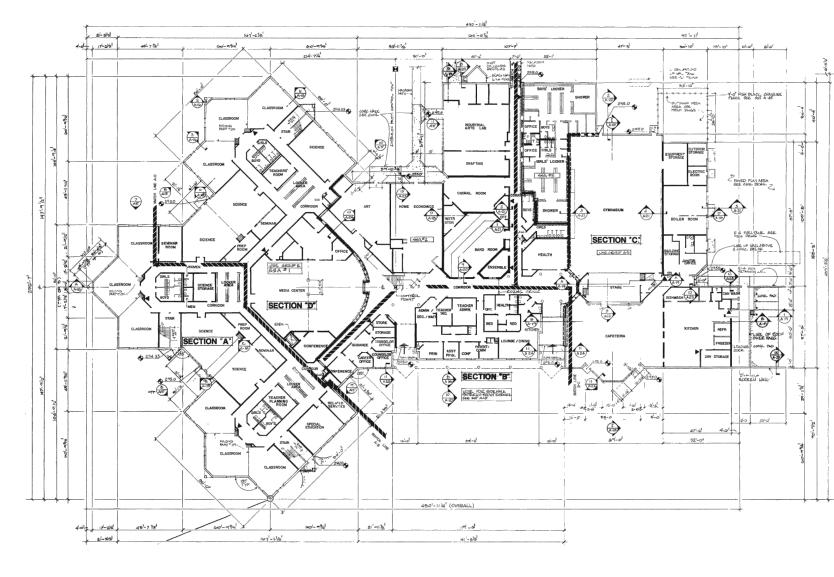


MAYFIELD WOODS MS - FIRST FLOOR PLAN

3 MAYFIELD WOODS MS - FIRST FLOOR PLAN



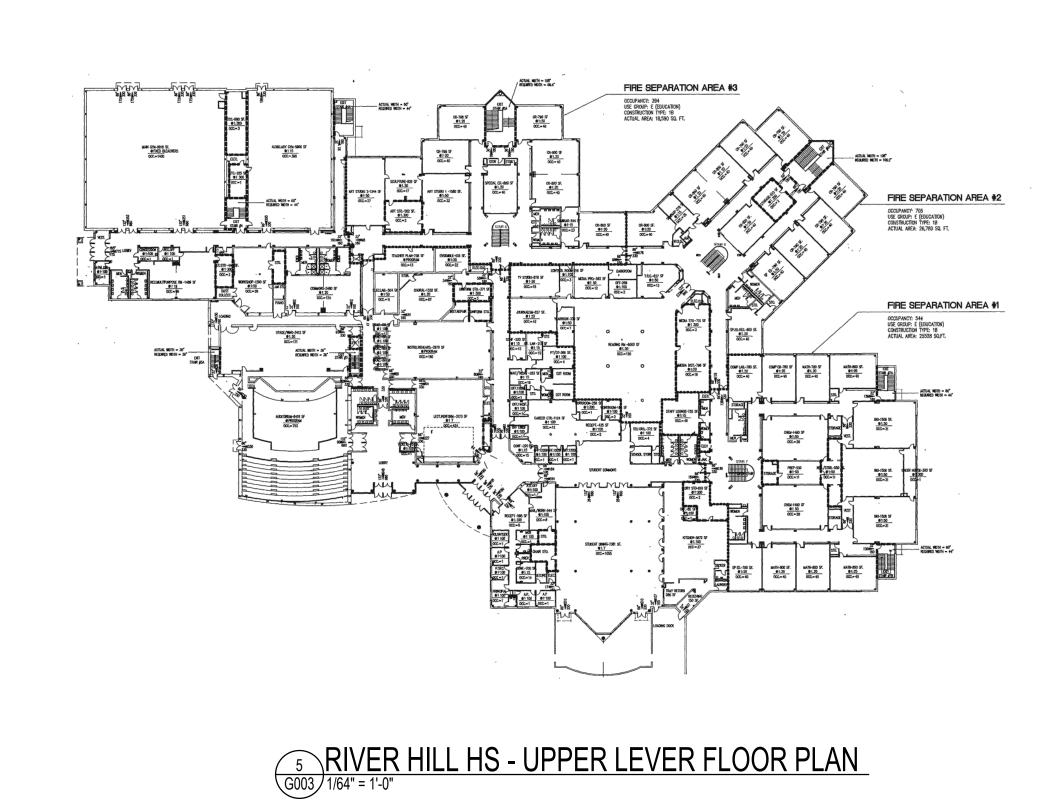

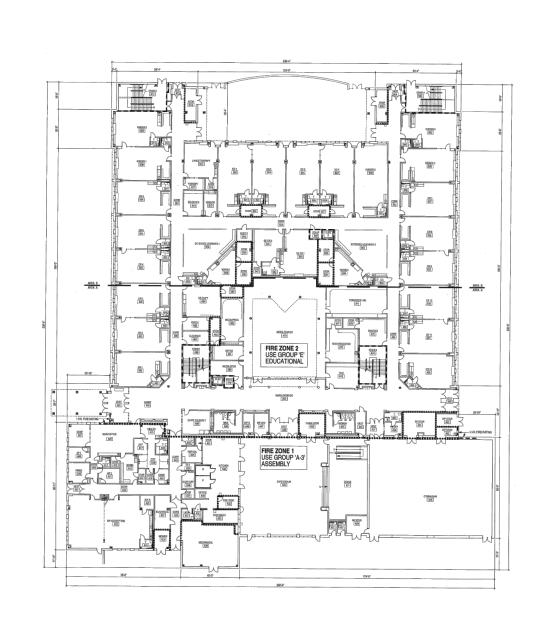

VETERANS ES - FIRST FLOOR PLAN

7
G003 1/64" = 1'-0"



HENRY ADAMS Consulting Engineers

MECHANICAL ELECTRICAL & PLUMBING ENGINEERS

MEP ENGINEERING
HENRY ADAMS,LLC
600 BALTIMORE AVENUE
SUITE 400
BALTIMORE, MD 21204
(410) 296-6500

PROJECT

HOWARD COUNTY PUBLIC SCHOOLS

CAFETERIA HVAC UNIT CONVERSIONS

CONSTRUCTION DOCUMENTS

SEA

PROFESSIONAL CERTIFICATION: I HEREBY CERTIFY THAT THESE DOCUMENTS WERE PREPARED OR APPROVED BY ME, AND THAT I AM A DULY LICENSED PROFESSIONAL ENGINEER UNDER THE LAWS OF THE STATE OF MARYLAND.

LICENSE NO: 37247

EXPIRATION DATE: 01/09/2024

NO.	DESCRIPTION	DATE
·		· ·

KEY PLAN

KEY PLANS

PROJECT NUMBER	PO-10028674
DATE	05/25/2023
DRAWN BY	ВМВ
CHECKED BY	SRH

6003

:018 3:54 PM

GENERAL MECHANICAL NOTES

(APPLICABLE TO ALL MECHANICAL DRAWINGS)

- 1. COORDINATE ALL MECHANICAL WORK WITH WORK OF OTHER TRADES SHOWN ON OTHER DRAWINGS. 2. INSTALL DUCTWORK SO THAT ALL DAMPERS ARE ACCESSIBLE.
- 3. CERTAIN ITEMS SUCH AS ACCESS DOORS, RISE AND DROPS IN DUCTWORK, ETC., ARE INDICATED ON THE DRAWINGS FOR CLARITY OR A SPECIFIC LOCATION REQUIREMENT AND SHALL NOT BE INTERPRETED AS THE EXTENT OF THE REQUIREMENTS FOR THESE ITEMS. THE CONTRACTOR SHALL BE RESPONSIBLE FOR THESE ITEMS AS REQUIRED ELSEWHERE IN THE CONTRACT DOCUMENTS.
- 4. WHERE THE INSTALLATION OF NEW SERVICES OR THE EXTENSION OF EXISTING SERVICES REQUIRES CUTTING OF EXISTING FLOORS, WALLS, PARTITIONS, ETC., CHECK FOR THE PRESENCE OF EXISTING MECHANICAL, PLUMBING AND ELECTRICAL SERVICES WITHIN OR IMMEDIATELY BENEATH CONSTRUCTION. EXERCISE NECESSARY PRECAUTIONS TO PREVENT DAMAGE TO THE SERVICES OR INJURY TO PERSONNEL DUE TO CONTACT WITH SAME. TEMPORARILY DISCONNECT SERVICES DURING THE CUTTING OPERATION. SCHEDULE SERVICE OUTAGES IN ADVANCE WITH THE COR.
- CONTRACTOR SHALL BE RESPONSIBLE FOR RESEARCHING ALL SYSTEMS THAT A PARTICULAR OUTAGE WILL AFFECT AS WELL AS LOCATING ALL SHUTOFF POINTS. INCLUDE THIS INFORMATION IN THE OUTAGE PLAN AND SUBMIT TO COR FOR APPROVAL.
- 6. EXCEPT AS OTHERWISE NOTED, LOCATE ALL ROOM THERMOSTATS ABOVE FINISHED FLOOR ON SAME HORIZONTAL CENTERLINE AS LIGHT SWITCH. WHERE LIGHT SWITCH AND THERMOSTAT ARE ADJACENT TO EACH OTHER, LIGHT SWITCH SHALL BE CLOSEST TO THE DOOR. COORDINATE WITH ELECTRICAL CONTRACTOR. NOTIFY THE COR OF ROOMS WHERE THE ABOVE LOCATION CANNOT BE MAINTAINED OR WHERE THERE IS A QUESTION ON LOCATION.
- 7. RECYCLE MERCURY SWITCH THERMOSTATS THAT ARE REMOVED. DELIVER RECYCLED THERMOSTATS TO PARTICIPATING WHOLESALERS.

N	MECHANICAL ABBREVIATION (APPLICABLE TO ALL MECHANICAL DRAWINGS)	IS
ACU ADJ		
AHU APD		
RΔS	RUII DING AUTOMATION SYSTEM	

•	CONNECT TO EXISTING	
•	END OF DEMOLITION	
\boxtimes	SUPPLY AIR DUCT	
	EXHAUST AIR DUCT	
RETURN AIR DUCT		
J VOLUME DAMPER		
─	BAROMETRIC RELIEF DAMPER	
	FAN MOTOR	
THERMOSTAT/ TEMPERATURE SENSOR		
©	COMBINATION THERMOSTAT/ HUMIDITY SENSOR/ CARBON DIOXIDE SENSOR	
0	OCCUPANCY SENSOR	
	REHEAT COIL	
	ELECTRIC DUCT HEATER	
	FLEXIBLE DUCT	
—— CHR —— CHILLED WATER RETURN		
—— CHS ——	CHILLED WATER SUPPLY	

MECHANICAL LEGEND (APPLICABLE TO ALL MECHANICAL DRAWINGS)

DESCRIPTION

SYMBOL

PIPE CAP

— — -HR - — — │ HEATING WATER RETURN

HEATING WATER SUPPLY

PLAN/SECTION DESIGNATION TOP - PLAN/SECTION REFERENCE BOTTOM - REFERENCED DRAWING

	SCHOOL LEGEND (APPLICABLE TO ALL MECHANICAL DRAWINGS)				
ACRONYM	SCHOOL				
DOES	DAYTON OAKS ELEMENTARY SCHOOL				
ELMS	ELKRIDGE LANDING MIDDLE SCHOOL				
FES	FULTON ELEMENTARY SCHOOL				
GHS	GLENELG HIGH SCHOOL				
GCES	GORMAN CROSSING ELEMENTARY SCHOOL				
HCES	HARPERS CHOICE MIDDLE SCHOOL				
HSES	HOLLIFIELD STATION ELEMENTARY SCHOOL				
MWMS	MAYFIELD WOODS MIDDLE SCHOOL				
OMHS	OAKLAND MILLS HIGH SCHOOL				
RHHS	RIVER HILL HIGH SCHOOL				
VES	VETERANS ELEMENTARY SCHOOL				

ACU ADJ AHU APD	AIR CONDITIONING UNIT ADJUSTABLE AIR HANDLING UNIT AIR PRESSURE DROP
BAS	BUILDING AUTOMATION SYSTEM
CC CFM CHS CHR COR CSR CS	COOLING COIL CUBIC MEET PER MINUTE CHILLED WATER SUPPLY CHILLED WATER RETURN CONTRACTING OFFICER'S REPRESENTATIVE CURRENT SENSING RELAY COMBINATION THERMOSTAT/ HUMIDITY SENSOR/ CARBON DIOXIDE SENSOR
D DIFF DPS DTC DTR DTS	DAMPER DIFFUSER DIFFERENTIAL PRESSURE SWITCH DUAL TEMPERATURE COIL DUAL TEMPERATURE RETURN DUAL TEMPERATURE SUPPLY
EA EAT EDH EF ES EWT EX	EXHAUST AIR ENTERING AIR TEMPERATURE ELECTRIC DUCT HEATER EXHAUST FAN ELEMENTARY SCHOOL ENTERING WATER TEMPERATURE EXISTING
F FLEX FST	FREEZESTAT FLEXIBLE DUCT FIRE STAT
G GPM	GRILLE GALLONS PER MINUTE
H HC HP HWC HS HR	HEIGHT / HUMIDITY SENSOR HEATING COIL HORSEPOWER HEATING WATER COIL HEATING WATER SUPPLY / HIGH SCHOOL HEATING WATER RETURN
KW	KILOWATT
LAT LWT	LEAVING AIR TEMPERATURE LEAVING WATER TEMPERATURE
M MAX MBH MIN MS	MECHANICAL MAXIMUM THOUSAND BTU PER HOUR MINIMUM MIDDLE SCHOOL
N NC NO	NORTH NORMALLY CLOSED NORMALLY OPEN/ NUMBER
O OA OED OS	OCCUPANCY SENSOR OUTDOOR AIR OPEN END DUCT OCCUPANCY SENSOR
PH	PHASE
RA RF RHC RTU RX	RETURN AIR RETURN FAN REHEAT COIL ROOFTOP AIR HANDLING UNIT REMOVE EXISTING
S SA SCR SD SF SPD S/S	END SWITCH SUPPLY AIR SILICON CONTROLLED RECTIFIER SMOKE DETECTOR SUPPLY FAN SPEED START/STOP
T TYP	TEMPERATURE / TEMPERATURE SENSOR TYPICAL
V VD VFD	VALVE / VOLTS VOLUME DAMPER VARIABLE FREQUENCY DRIVE
W WPD	WIDTH WATER PRESSURE DROP



HENRY ADAMS Consulting Engineers

MECHANICAL ELECTRICAL & PLUMBING ENGINEERS

MEP ENGINEERING HENRY ADAMS,LLC 600 BALTIMORE AVENUE SUITE 400 BALTIMORE, MD 21204 (410) 296-6500

PROJECT

HOWARD COUNTY PUBLIC SCHOOLS

CAFETERIA HVAC UNIT CONVERSIONS

CONSTRUCTION DOCUMENTS

PROFESSIONAL CERTIFICATION: I HEREBY CERTIFY THAT THESE DOCUMENTS WERE PREPARED OR APPROVED BY ME, AND THAT I AM A DULY LICENSED PROFESSIONAL ENGINEER UNDER THE LAWS OF THE STATE OF MARYLAND.

EXPIRATION DATE: 01/09/2024

NO.	DESCRIPTION	DATE

MECHANICAL COVER SHEET

PO-10028674 05/25/2023 DRAWN BY CHECKED BY

-) REMOVE EXISTING TEMPERATURE SENSOR FOR THE AIR HANDLING UNIT. REMOVE ALL CONTROL WIRING OR PNEUMATIC TUBING BACK TO MAIN ATC PANEL. PROVIDE COMBINATION DDC SPACE TEMPERATURE, HUMIDITY & CO2 SENSOR IN SAME LOCATION AS EXISTING TEMPERATURE SENSOR.
- 2) PROVIDE DUCT-MOUNTED TEMPERATURE SENSOR. REFER TO AUTOMATIC CONTROLS DRAWINGS FOR ADDITIONAL INFORMATION
- EXISTING CEILING DEVICES. CONTRACTOR SHALL ADJUST SENSOR QUANTITY AND LOCATIONS BASED ON SENSOR RANGE.
- 4) BALANCE THE AIRFLOW FOR ALL AIR INLETS AND OUTLETS TO THE DESIGN AIRFLOW RATES SHOWN ON THE ORIGINAL BUILDING DRAWINGS. REFER TO DRAWING 1/M201 FOR THE DESIGN AIRFLOW RATES.

DRAWING NOTES: (APPLICABLE TO THIS DRAWING ONLY)

- EXISTING SHOWN WITH LIGHT WEIGHT LINE, ————
- DEMOLITION SHOWN WITH HEAVY WEIGHT, DASHED LINE, -----NEW WORK SHOWN WITH HEAVY WEIGHT LINE, ————
- THAT PREVENT EXECUTION OF THE WORK AS INDICATED, OR THERE IS A QUESTION REGARDING SCOPE OF WORK OR LIMITS OF
- REQUIREMENT AND CONTRACT DRAWINGS TO THE COR FOR RESOLUTION
- PLUS HIGH NRC LAY-IN PANELS WITH HIGH MOISTURE AND HIGH HEAT RESISTANCE).





MECHANICAL ELECTRICAL & PLUMBING ENGINEERS

MEP ENGINEERING HENRY ADAMS,LLC 600 BALTIMORE AVENUE SUITE 400 BALTIMORE, MD 21204

PROJECT

(410) 296-6500

HOWARD COUNTY PUBLIC SCHOOLS


CAFETERIA HVAC UNIT CONVERSIONS

CONSTRUCTION DOCUMENTS

PROFESSIONAL CERTIFICATION: I HEREBY CERTIFY THAT THESE DOCUMENTS WERE PREPARED OR APPROVED BY ME, AND THAT I AM A DULY LICENSED PROFESSIONAL ENGINEER UNDER THE LAWS OF THE STATE OF MARYLAND.


LICENSE NO: 37247 EXPIRATION DATE: 01/09/2024


NO.	DESCRIPTION	DATE	
KEY PLAN	KEY PLAN		

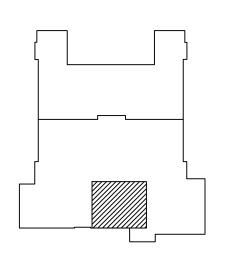


DAYTON OAKS ES - MECHANICAL WORK

PO-10028674 05/25/2023 CHECKED BY

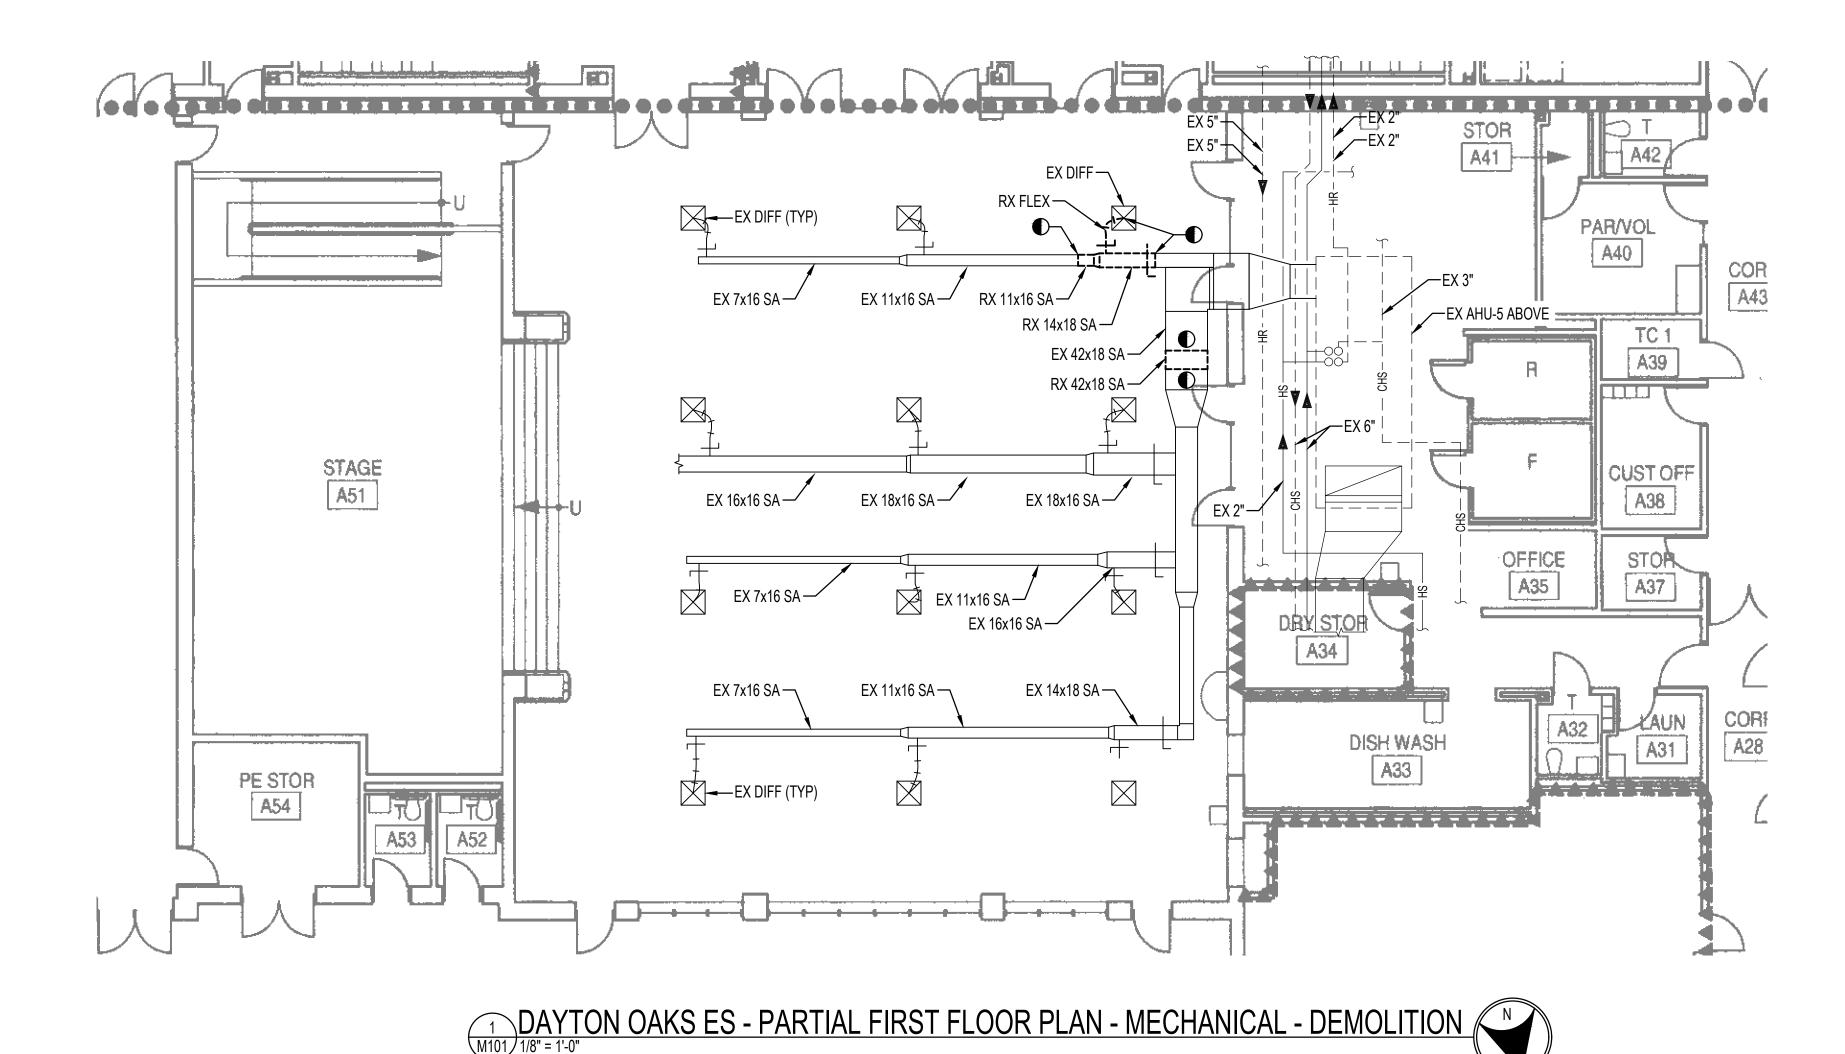


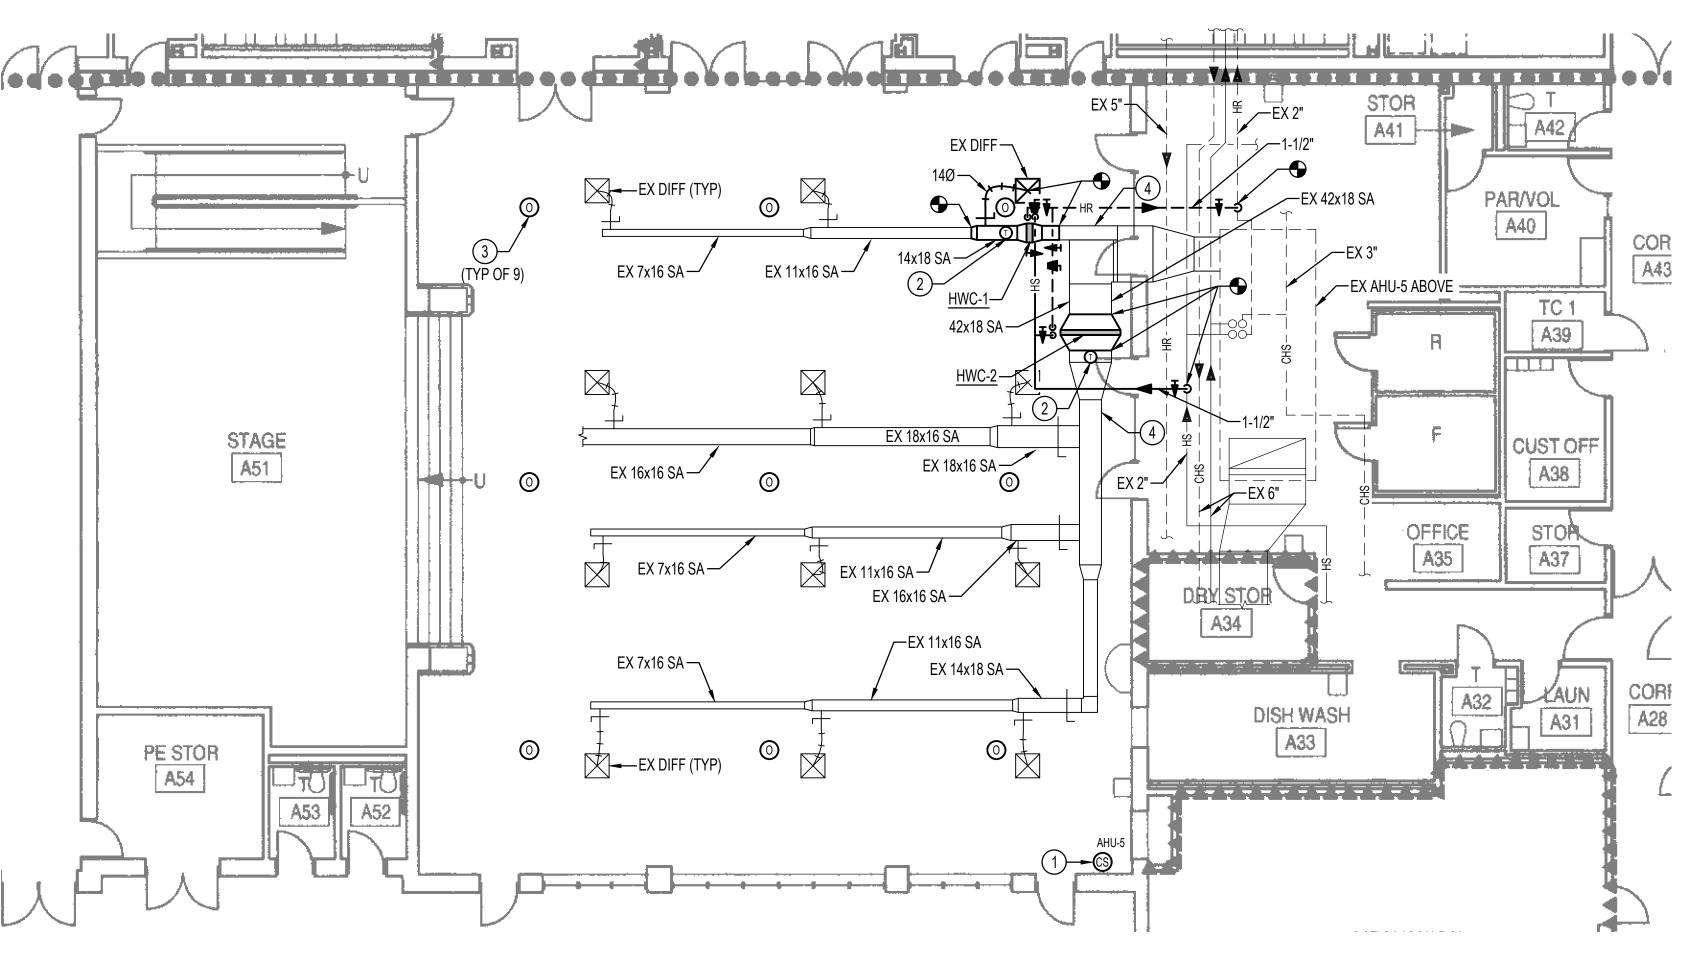


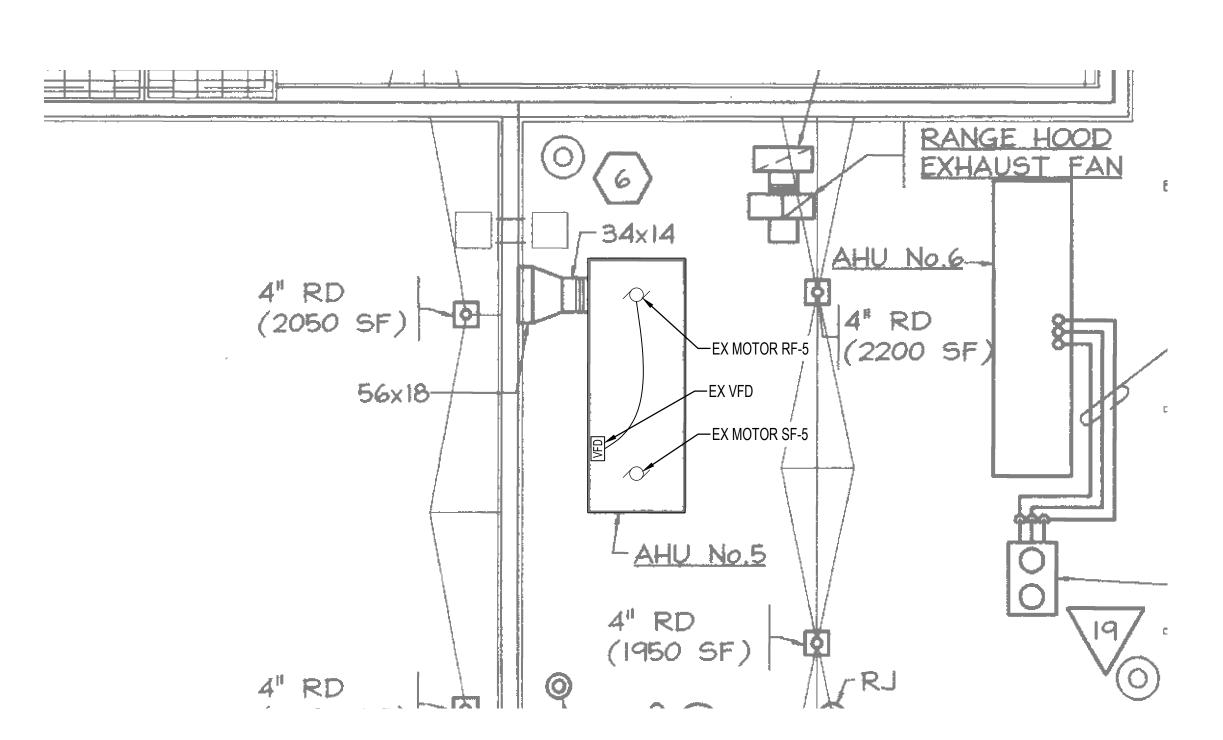


DAYTON OAKS ES - PARTIAL ROOF PLAN - MECHANICAL - EXISTING

NOTE: REFER TO AUTOMATIC CONTROLS FOR REQUIRED NEW WORK

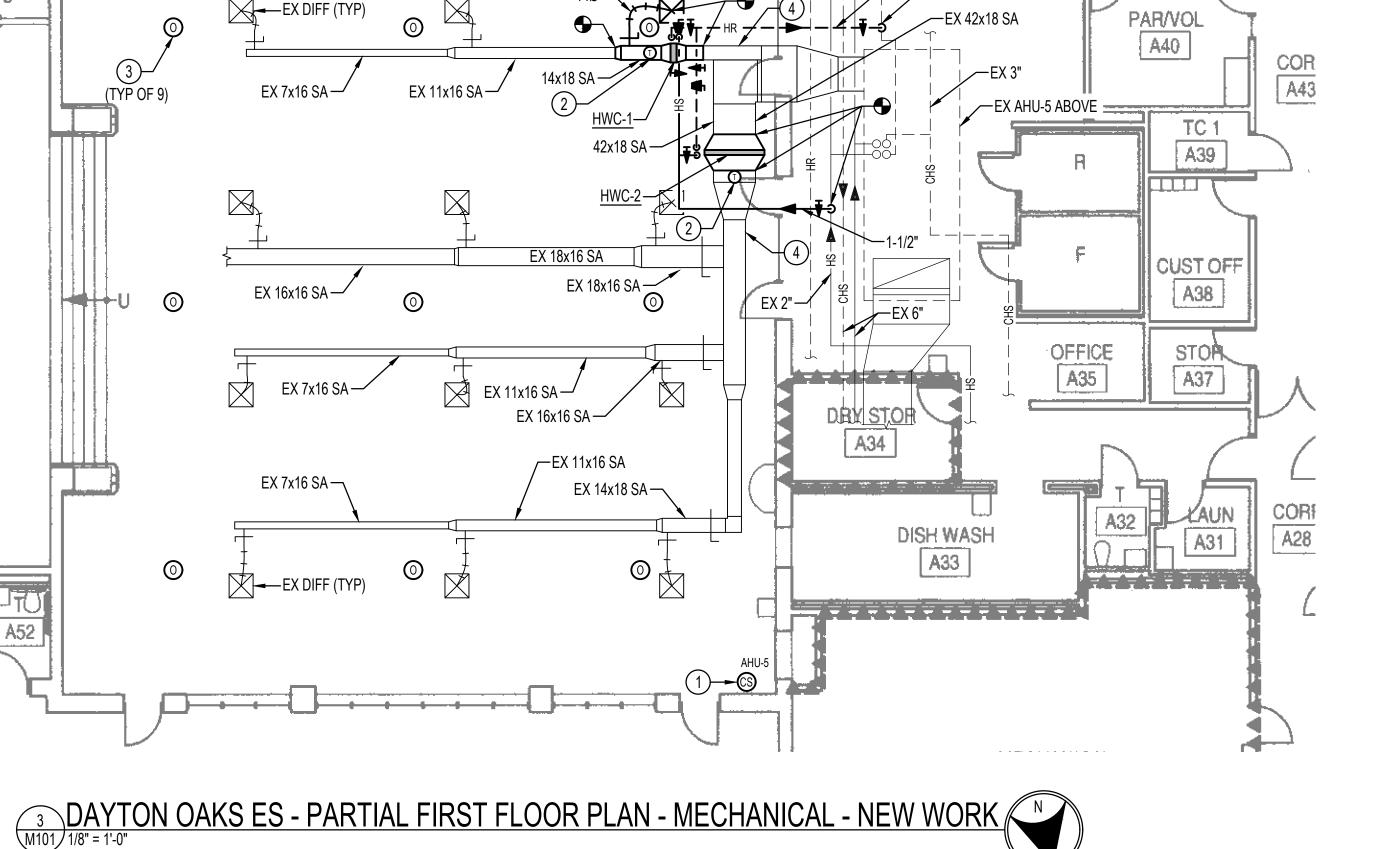

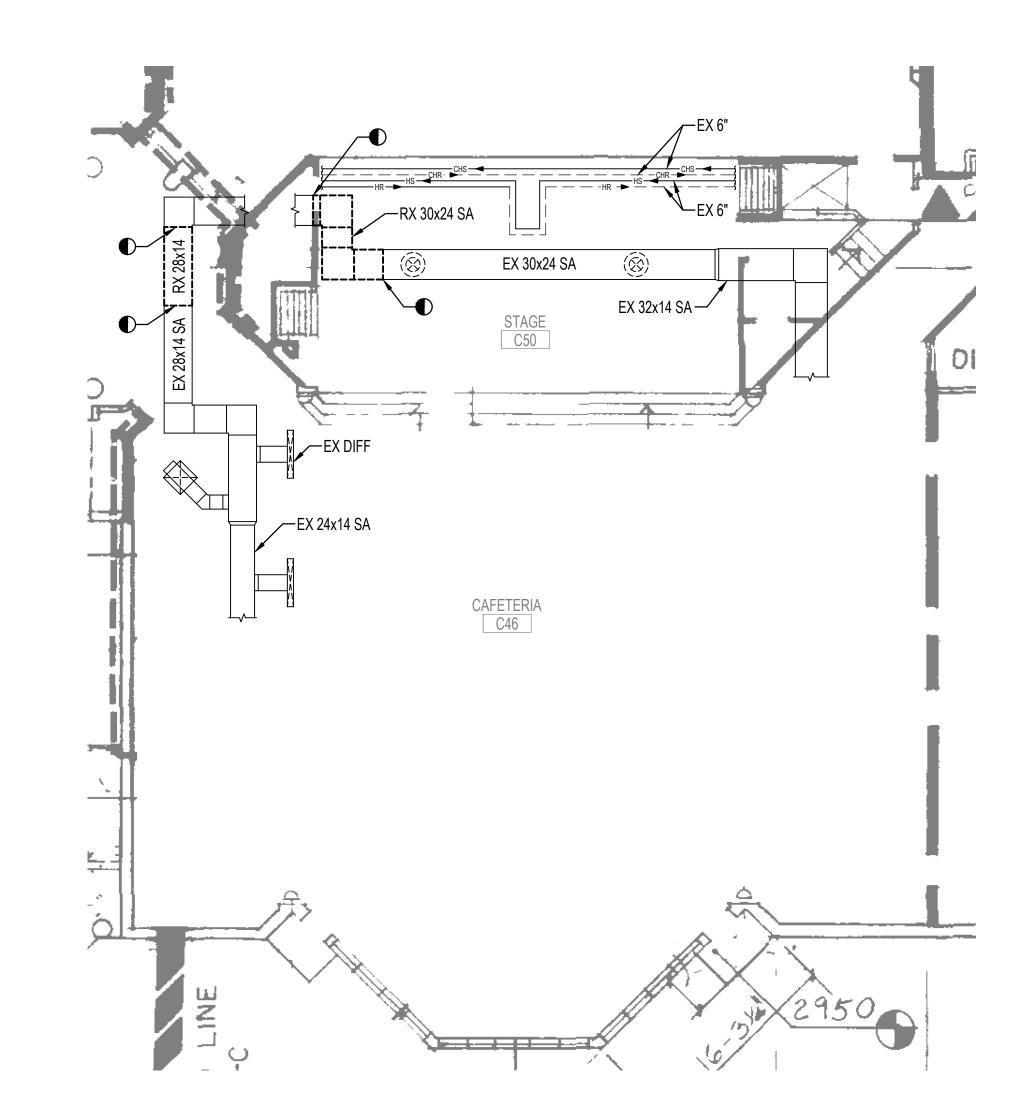

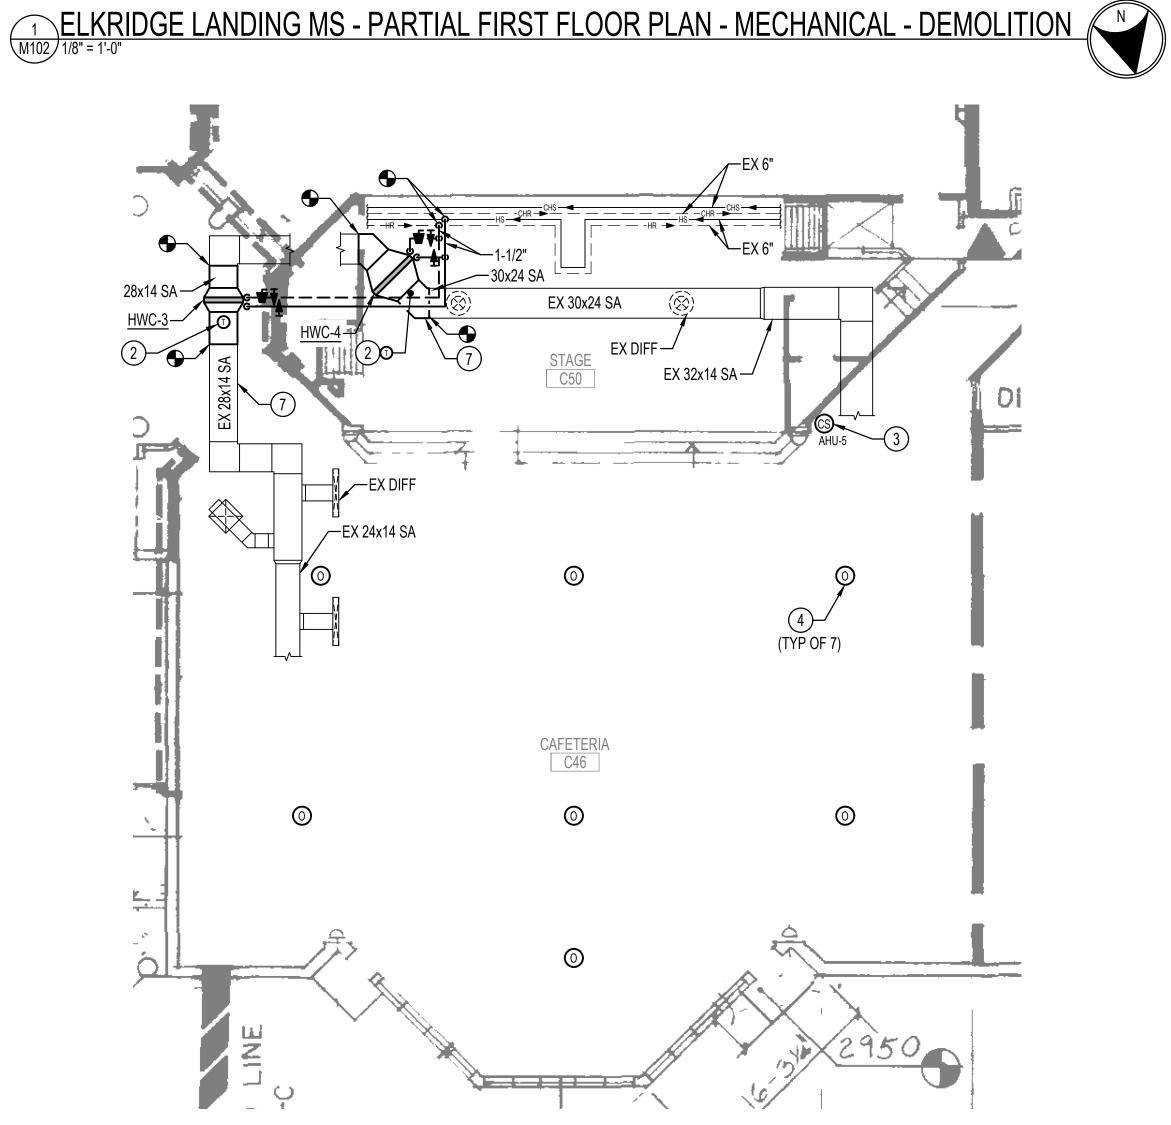

3 ELKRIDGE LANDING MS - PARTIAL FIRST FLOOR PLAN - MECHANICAL - NEW WORK M102 1/8" = 1'-0"

SPECIAL NOTES: (APPLICABLE TO THIS DRAWING ONLY)

- 1) PROVIDE NEW INVERTER DUTY FAN MOTOR FOR ELMS-SF-5. REFER TO SCHEDULE ON DRAWING M801 FOR SIZE.
- 2) PROVIDE DUCT-MOUNTED TEMPERATURE SENSOR. REFER TO AUTOMATIC CONTROLS DRAWINGS FOR ADDITIONAL INFORMATION.
- B) REMOVE EXISTING TEMPERATURE SENSOR FOR THE AIR HANDLING UNIT. REMOVE ALL CONTROL WIRING OR PNEUMATIC TUBING BACK TO MAIN ATC PANEL. PROVIDE COMBINATION DDC SPACE TEMPERATURE, HUMIDITY & CO2 SENSOR FOR EACH AIR HANDLING UNIT IN SAME LOCATION AS EXISTING TEMPERATURE SENSOR.
- 4) PROVIDE CEILING-MOUNTED SPACE OCCUPANCY SENSORS FOR AHU-5. COORDINATE SPACE OCCUPANCY SENSOR LOCATIONS WITH EXISTING CEILING DEVICES. CONTRACTOR SHALL ADJUST SENSOR QUANTITY AND LOCATIONS BASED ON SENSOR RANGE.
- 5) PROVIDE VFD IN NEMA-3R ENCLOSURE. VFD SHALL BE MOUNTED ON UNITSTRUT FRAMING ON ROOF. UNITSTRUT FRAMING SHALL BE SUPPORTED BY EXISTING STRUCTURE.
- (6) PROVIDE JACE CONTROLLER FOR EXISTING AHU-5. INTEGRATE THE JACE CONTROLLER INTO THE EXISTING HONEYWELL TRIDIUM BAS. COORDINATE WITH HCPSS FOR PREFERRED LOCATION.
- 7) BALANCE THE AIRFLOW FOR ALL AIR INLETS AND OUTLETS TO THE DESIGN AIRFLOW RATES SHOWN ON THE ORIGINAL BUILDING DRAWINGS. REFER TO DRAWING 2/M201 FOR THE DESIGN AIRFLOW RATES.
- DEMOLITION SHOWN WITH HEAVY WEIGHT, DASHED LINE, -----


EXISTING SHOWN WITH LIGHT WEIGHT LINE, ————

NEW WORK SHOWN WITH HEAVY WEIGHT LINE, ———


DRAWING NOTES: (APPLICABLE TO THIS DRAWING ONLY)

- THAT PREVENT EXECUTION OF THE WORK AS INDICATED, OR THERE IS A QUESTION REGARDING SCOPE OF WORK OR LIMITS OF DISTURBANCE, THE CONTRACTOR SHALL IMMEDIATELY NOTIFY THE COR IN WRITING AND AWAIT WRITTEN DIRECTION BEFORE PROCEEDING WITH THE WORK.
- TRANSMITTERS, AND CONTROL DEVICES. PRIOR TO COMMENCING INSTALLATION WORK, REFER CONFLICTS BETWEEN THIS REQUIREMENT AND CONTRACT DRAWINGS TO THE COR FOR RESOLUTION

PLUS HIGH NRC LAY-IN PANELS WITH HIGH MOISTURE AND HIGH HEAT RESISTANCE).

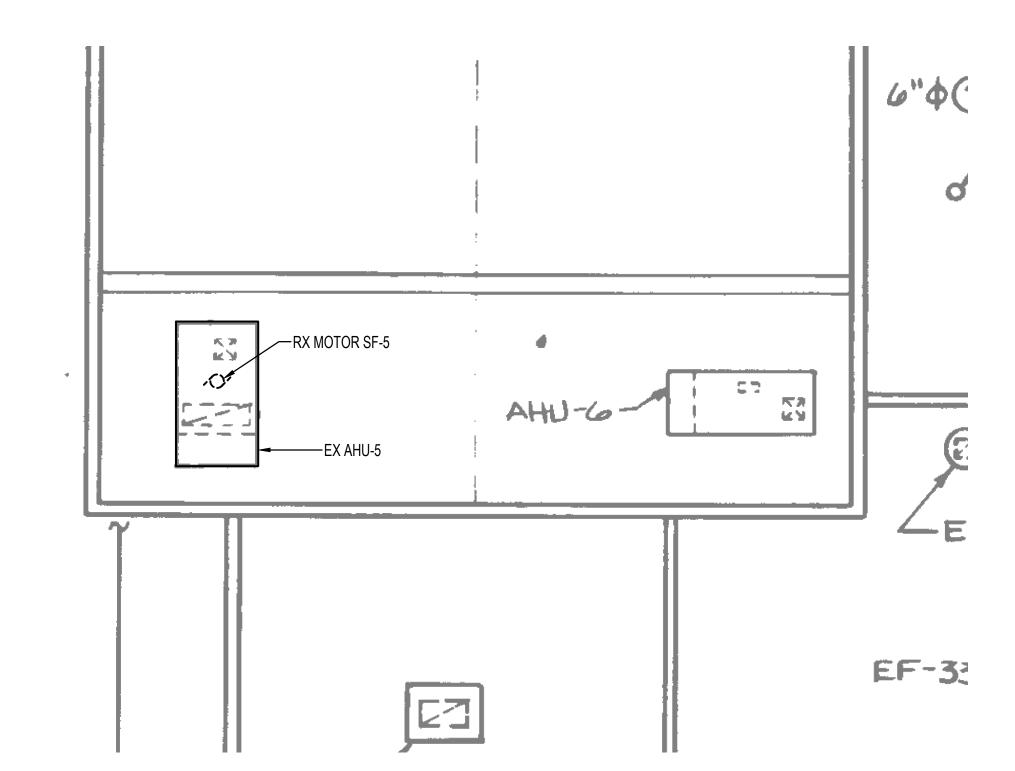



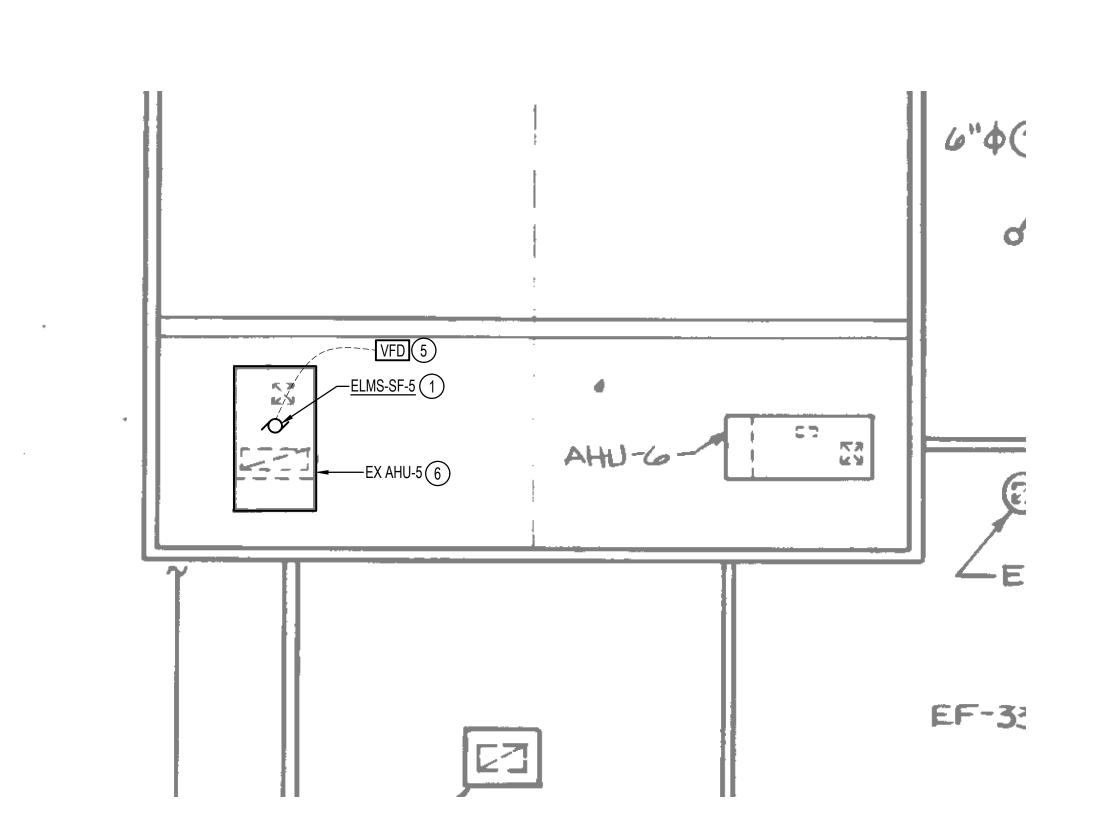

4 ELKRIDGE LANDING MS - PARTIAL ROOF PLAN - MECHANICAL - NEW WORK M102 1/8" = 1'-0"







MECHANICAL ELECTRICAL & PLUMBING ENGINEERS

MEP ENGINEERING HENRY ADAMS,LLC 600 BALTIMORE AVENUE SUITE 400 BALTIMORE, MD 21204 (410) 296-6500

PROJECT

HOWARD COUNTY PUBLIC SCHOOLS

CAFETERIA HVAC UNIT CONVERSIONS


CONSTRUCTION DOCUMENTS

PROFESSIONAL CERTIFICATION: I HEREBY CERTIFY THAT THESE DOCUMENTS WERE PREPARED OR APPROVED BY ME, AND THAT I AM A DULY LICENSED PROFESSIONAL ENGINEER UNDER THE LAWS OF THE STATE OF MARYLAND.

LICENSE NO: 37247

EXPIRATION DATE: 01/09/2024 DESCRIPTION

KEY PLAN

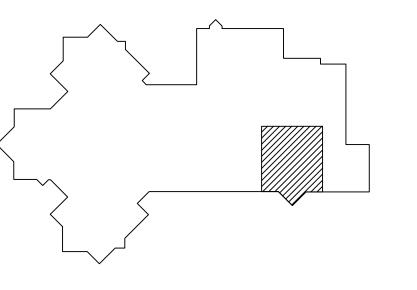

ELKRIDGE LANDING MS - MECHANICAL WORK

PROJECT NUMBER PO-10028674 05/25/2023 DRAWN BY CHECKED BY

M102

- 1) PROVIDE NEW INVERTER DUTY FAN MOTOR FOR FES-RF-3. REFER TO SCHEDULE ON DRAWING M801 FOR SIZE.
- 2 PROVIDE NEW INVERTER DUTY FAN MOTOR FOR FES-SF-3. REFER TO SCHEDULE ON DRAWING M801 FOR SIZE.
- 3 REMOVE EXISTING TEMPERATURE SENSOR FOR THE AIR HANDLING UNIT. REMOVE ALL CONTROL WIRING OR PNEUMATIC TUBING BACK TO MAIN ATC PANEL. PROVIDE COMBINATION DDC SPACE TEMPERATURE, HUMIDITY & CO2 SENSOR FOR EACH AIR HANDLING UNIT IN SAME LOCATION AS EXISTING TEMPERATURE SENSOR.
- 4 PROVIDE DUCT-MOUNTED TEMPERATURE SENSOR. REFER TO AUTOMATIC CONTROLS DRAWINGS FOR ADDITIONAL INFORMATION.
- 5) PROVIDE CEILING-MOUNTED SPACE OCCUPANCY SENSORS FOR AHU-3. COORDINATE SPACE OCCUPANCY SENSOR LOCATIONS WITH EXISTING CEILING DEVICES. CONTRACTOR SHALL ADJUST SENSOR QUANTITY AND LOCATIONS BASED ON SENSOR RANGE.
- 6) PROVIDE VFD IN NEMA-3R ENCLOSURE. VFD SHALL BE MOUNTED ON UNITSTRUT FRAMING ON ROOF. UNITSTRUT FRAMING SHALL BE SUPPORTED BY EXISTING STRUCTURE.
- 7) BALANCE THE AIRFLOW FOR ALL AIR INLETS AND OUTLETS TO THE DESIGN AIRFLOW RATES SHOWN ON THE ORIGINAL BUILDING DRAWINGS. REFER TO DRAWING 3/M201 FOR THE DESIGN AIRFLOW RATES.
- 1. EXISTING SHOWN WITH LIGHT WEIGHT LINE, ————
- . DEMOLITION SHOWN WITH HEAVY WEIGHT, DASHED LINE, -----

DRAWING NOTES: (APPLICABLE TO THIS DRAWING ONLY)

- NEW WORK SHOWN WITH HEAVY WEIGHT LINE,
 INFORMATION SHOWN ON THIS DRAWING PERTAINING TO EXISTING CONDITIONS HAS BEEN OBTAINED FROM AVAILABLE BUT DRAWINGS OR GENERAL FIELD OBSERVATIONS AND MAY NOT INDICATE ACTUAL EXISTING CONDITIONS IN DETAIL OR DIME
- DRAWINGS OR GENERAL FIELD OBSERVATIONS AND MAY NOT INDICATE ACTUAL EXISTING CONDITIONS IN DETAIL OR DIMENSION. EXISTING CONDITIONS ARE SHOWN IN AN APPROXIMATE WAY ONLY. THE CONTRACTOR SHALL BE RESPONSIBLE FOR DETERMINING THE ACTUAL EXISTING CONDITIONS PRIOR TO FABRICATION OR PERFORMANCE OF ANY WORK. SHOULD CONDITIONS BE DISCOVERED THAT PREVENT EXECUTION OF THE WORK AS INDICATED, OR THERE IS A QUESTION REGARDING SCOPE OF WORK OR LIMITS OF DISTURBANCE, THE CONTRACTOR SHALL IMMEDIATELY NOTIFY THE COR IN WRITING AND AWAIT WRITTEN DIRECTION BEFORE PROCEEDING WITH THE WORK.
- ALL ITEMS THAT REQUIRE ACCESS FOR OPERATING, CLEANING, SERVICING, MAINTENANCE, AND CALIBRATION, SHALL BE EASILY AND SAFELY ACCESSIBLE. EXAMPLES OF THESE ITEMS INCLUDE, BUT ARE NOT LIMITED TO: ALL TYPES OF VALVES, FILTERS, STRAINERS, TRANSMITTERS, AND CONTROL DEVICES. PRIOR TO COMMENCING INSTALLATION WORK, REFER CONFLICTS BETWEEN THIS REQUIREMENT AND CONTRACT DRAWINGS TO THE COR FOR RESOLUTION.
- FOR WORK ABOVE SUSPENDED CEILINGS: CAREFULLY REMOVE CEILING TILES AND CEILING GRID AS REQUIRED. TEMPORARILY RELOCATE AND PROTECT EXISTING LIGHTING FIXTURES AND OTHER DEVICES INSTALLED IN THE CEILING, SUCH AS PUBLIC ADDRESS SPEAKERS, WIRELESS ACCESS POINTS, ETC. RELOCATE EXISTING ELECTRICAL POWER WIRING, CONDUITS, AND SPRINKLER PIPING AS REQUIRED TO ACCOMMODATE THE WORK. UPON COMPLETION OF WORK ABOVE CEILING, PROVIDE A NEW CEILING GRID (EQUAL TO CHICAGO METALLIC 200 SERIES, USG DONN BRAND DX, OR ARMSTRONG PRELUDE XL SERIES) AND NEW CEILING TILES (EQUAL TO ARMSTRONG SCHOOL ZONE FINE FISSURED, CERTAINTEED FINE FISSURED HIGH NRC, OR UNITED STATES GYPSUM RADAR CLIMATE PLUS HIGH NRC LAY-IN PANELS WITH HIGH MOISTURE AND HIGH HEAT RESISTANCE).





MECHANICAL ELECTRICAL & PLUMBING ENGINEERS

MEP ENGINEERING
HENRY ADAMS,LLC
600 BALTIMORE AVENUE
SUITE 400
BALTIMORE, MD 21204

PROJECT

(410) 296-6500

HOWARD COUNTY PUBLIC SCHOOLS

CAFETERIA HVAC UNIT CONVERSIONS

CONSTRUCTION DOCUMENTS


SEAL

PROFESSIONAL CERTIFICATION: I HEREBY CERTIFY THAT THESE DOCUMENTS WERE PREPARED OR APPROVED BY ME, AND THAT I AM A DULY LICENSED PROFESSIONAL ENGINEER UNDER THE LAWS OF THE STATE OF MARYLAND.

LICENSE NO: 37247

EXPIRATION DATE: 01/09/2024		
NO.	DESCRIPTION	DATE


KEY PLAN

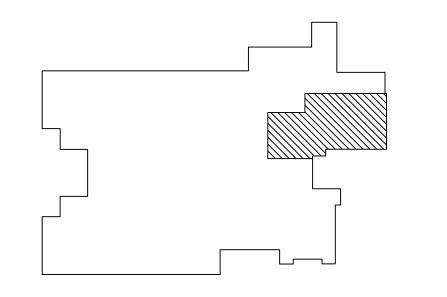


FULTON ES - MECHANICAL WORK


PROJECT NUMBER	PO-10028674
DATE	05/25/2023
DRAWN BY	NCV
CHECKED BY	BMB


M103

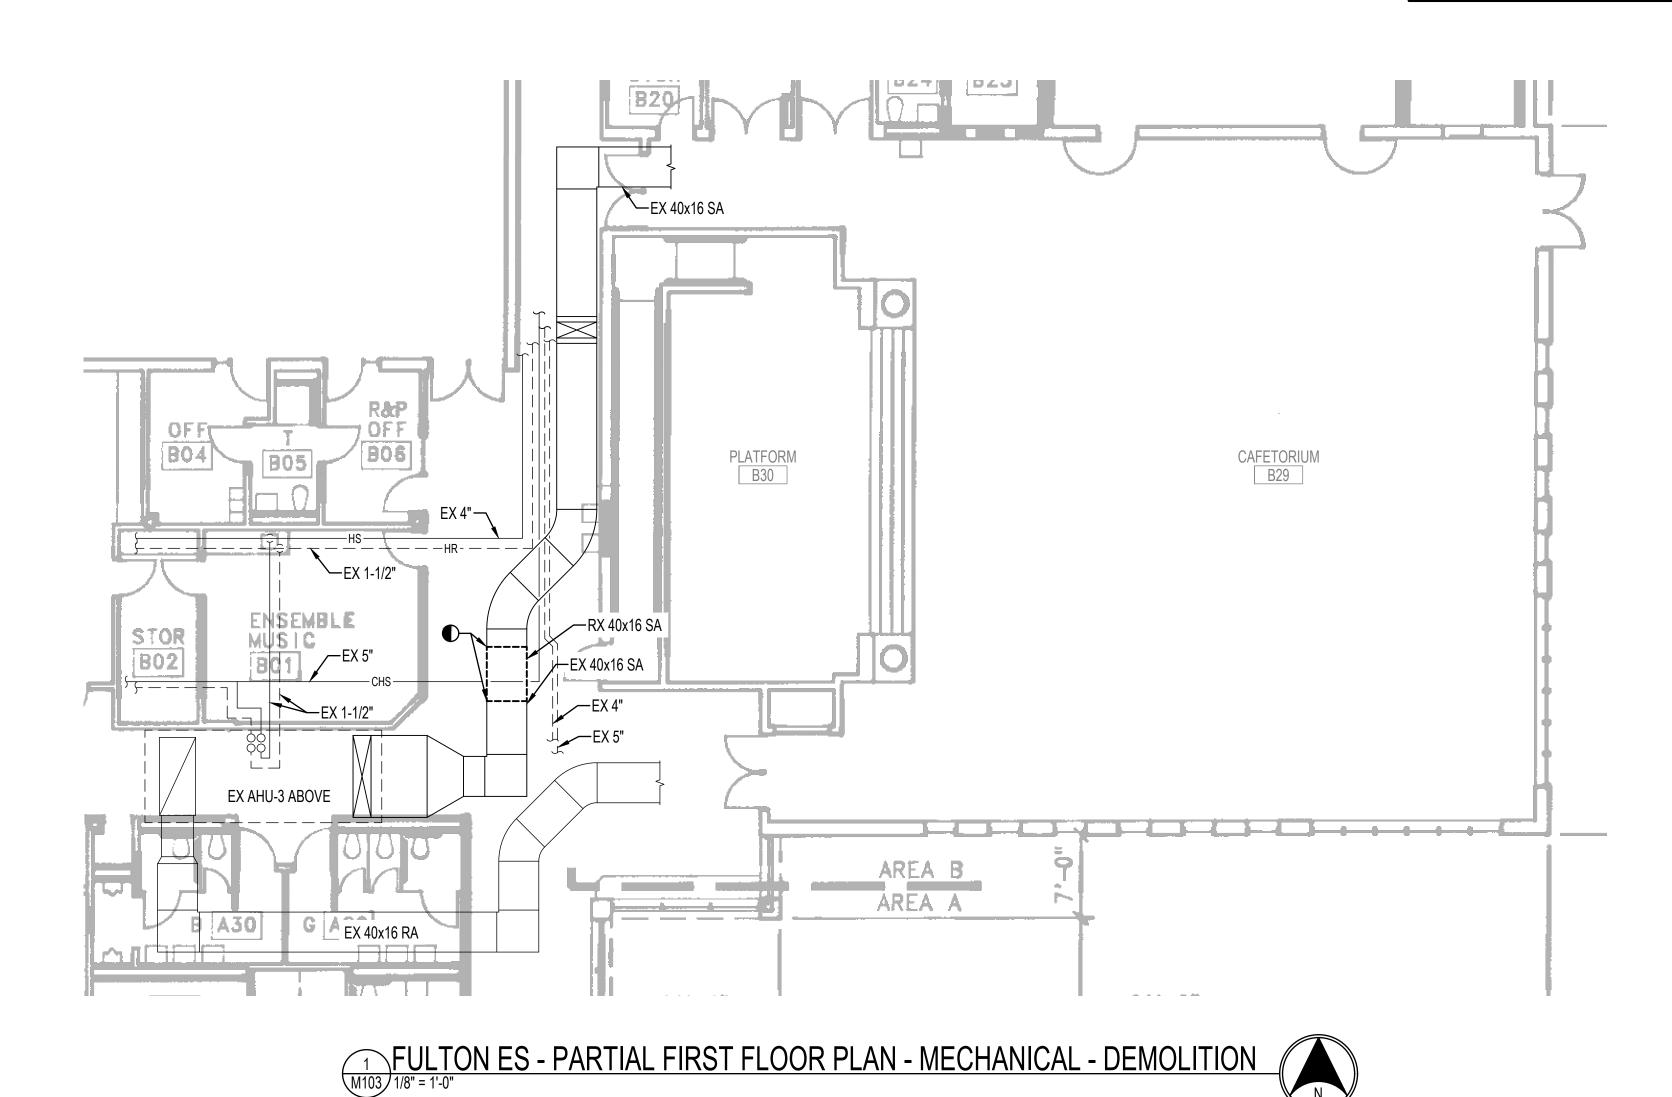

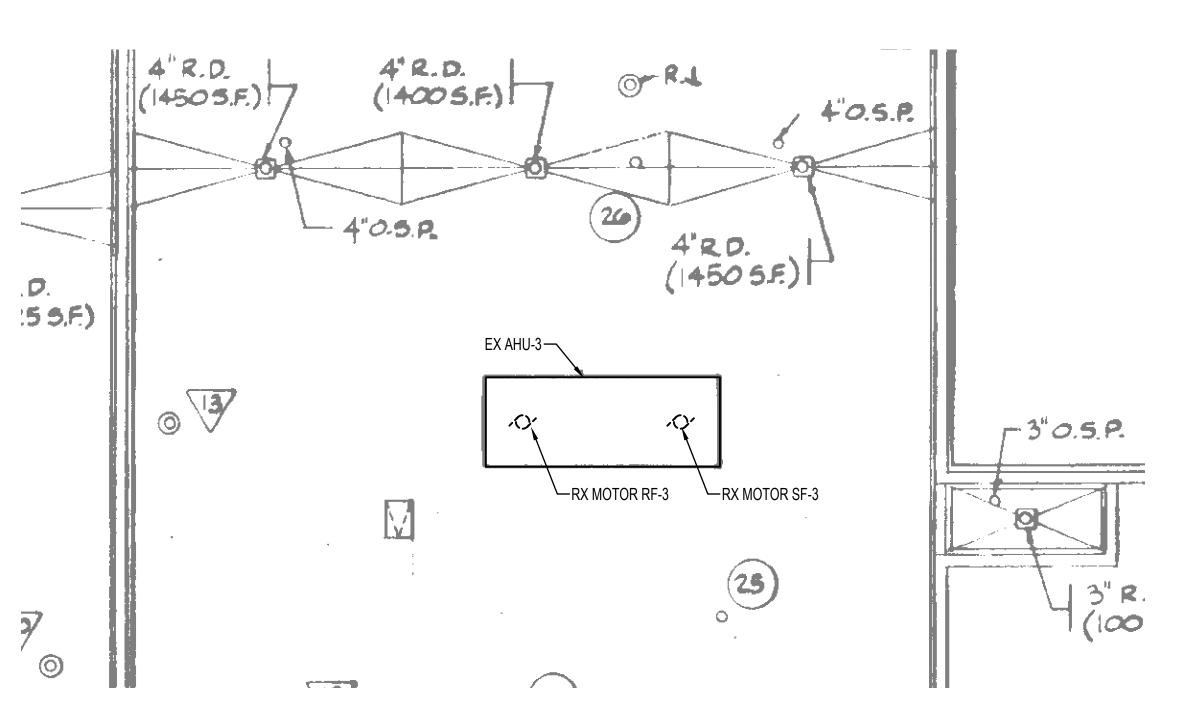



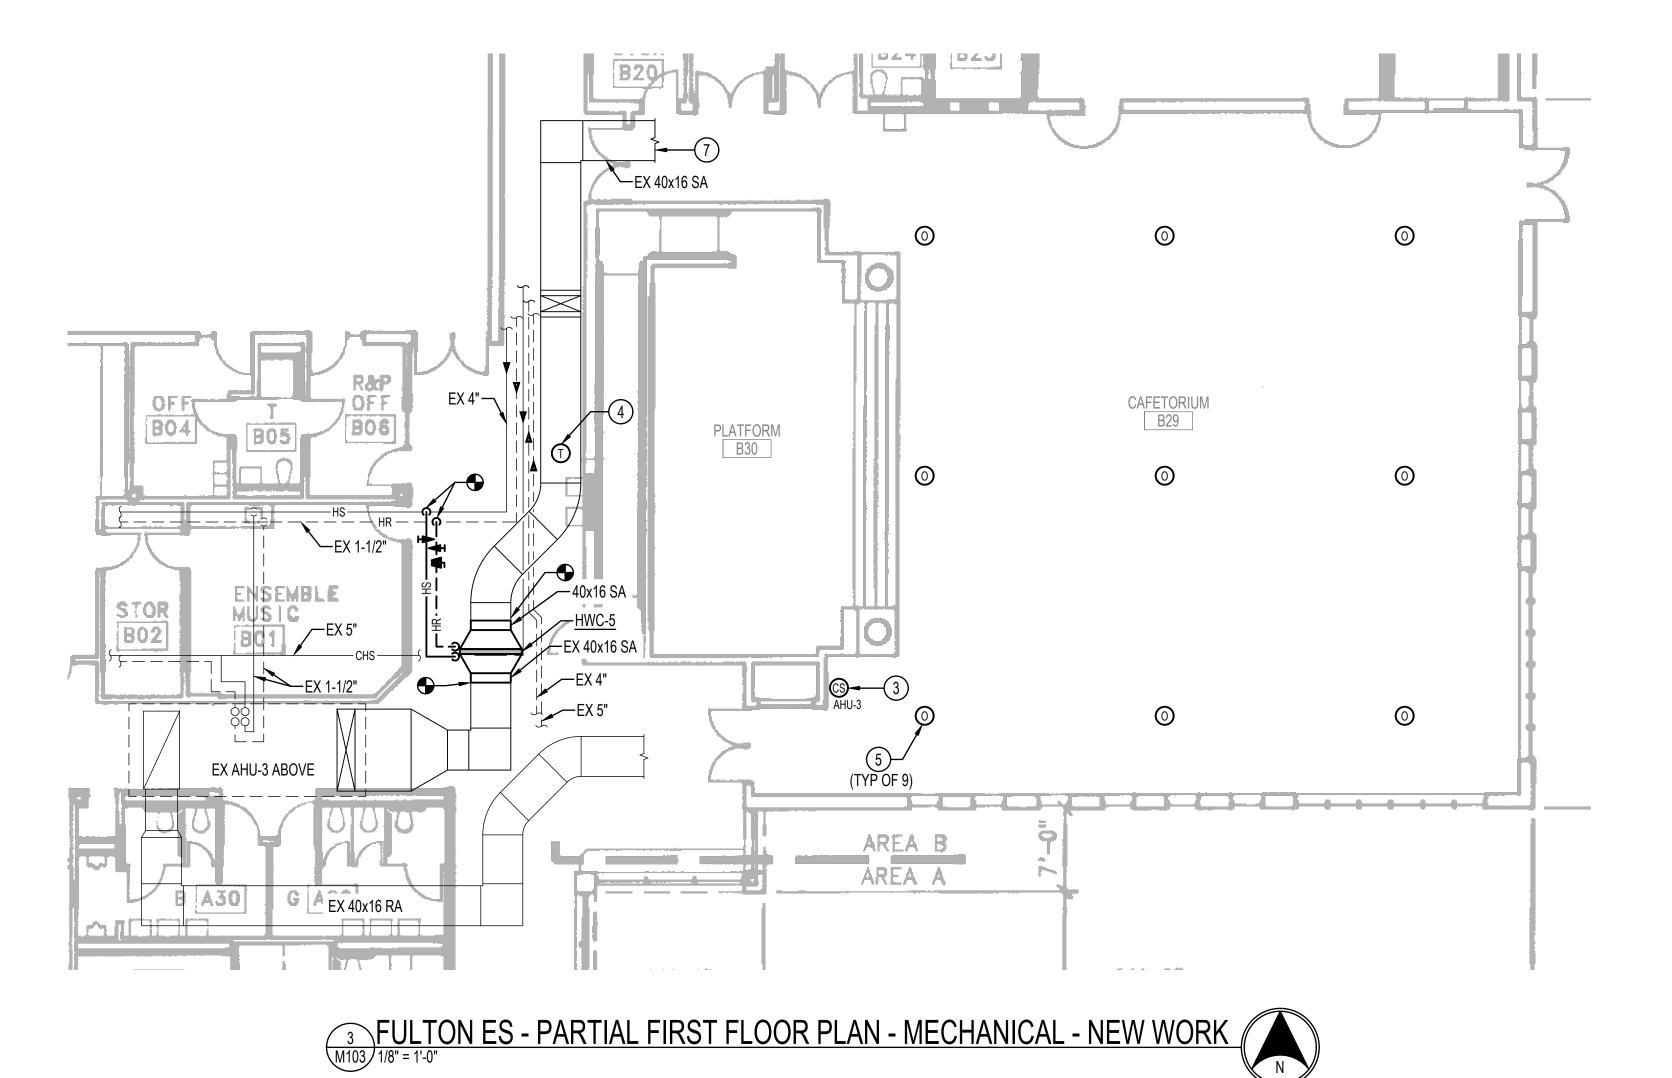


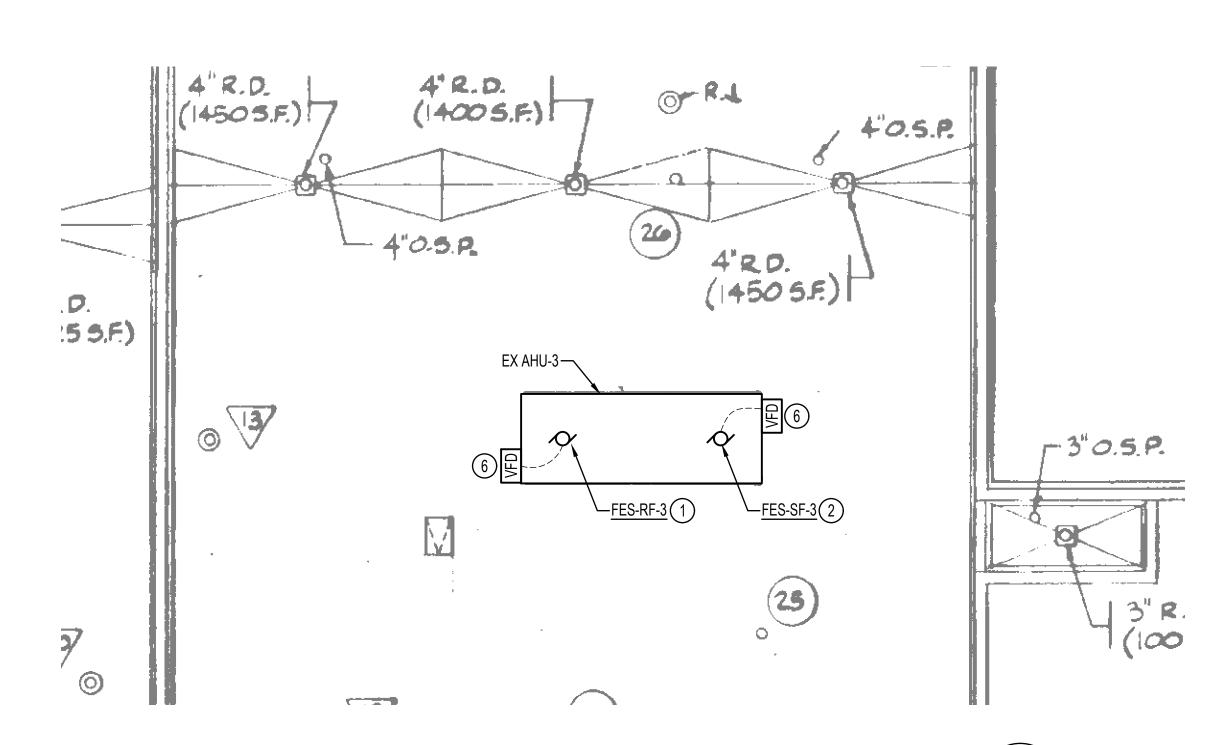

FULTON ES - PARTIAL ROOF PLAN - MECHANICAL - NEW WORK

M103 1/8" = 1'-0"

0 4 8 16 24 FT 1/8" = 1' - 0"

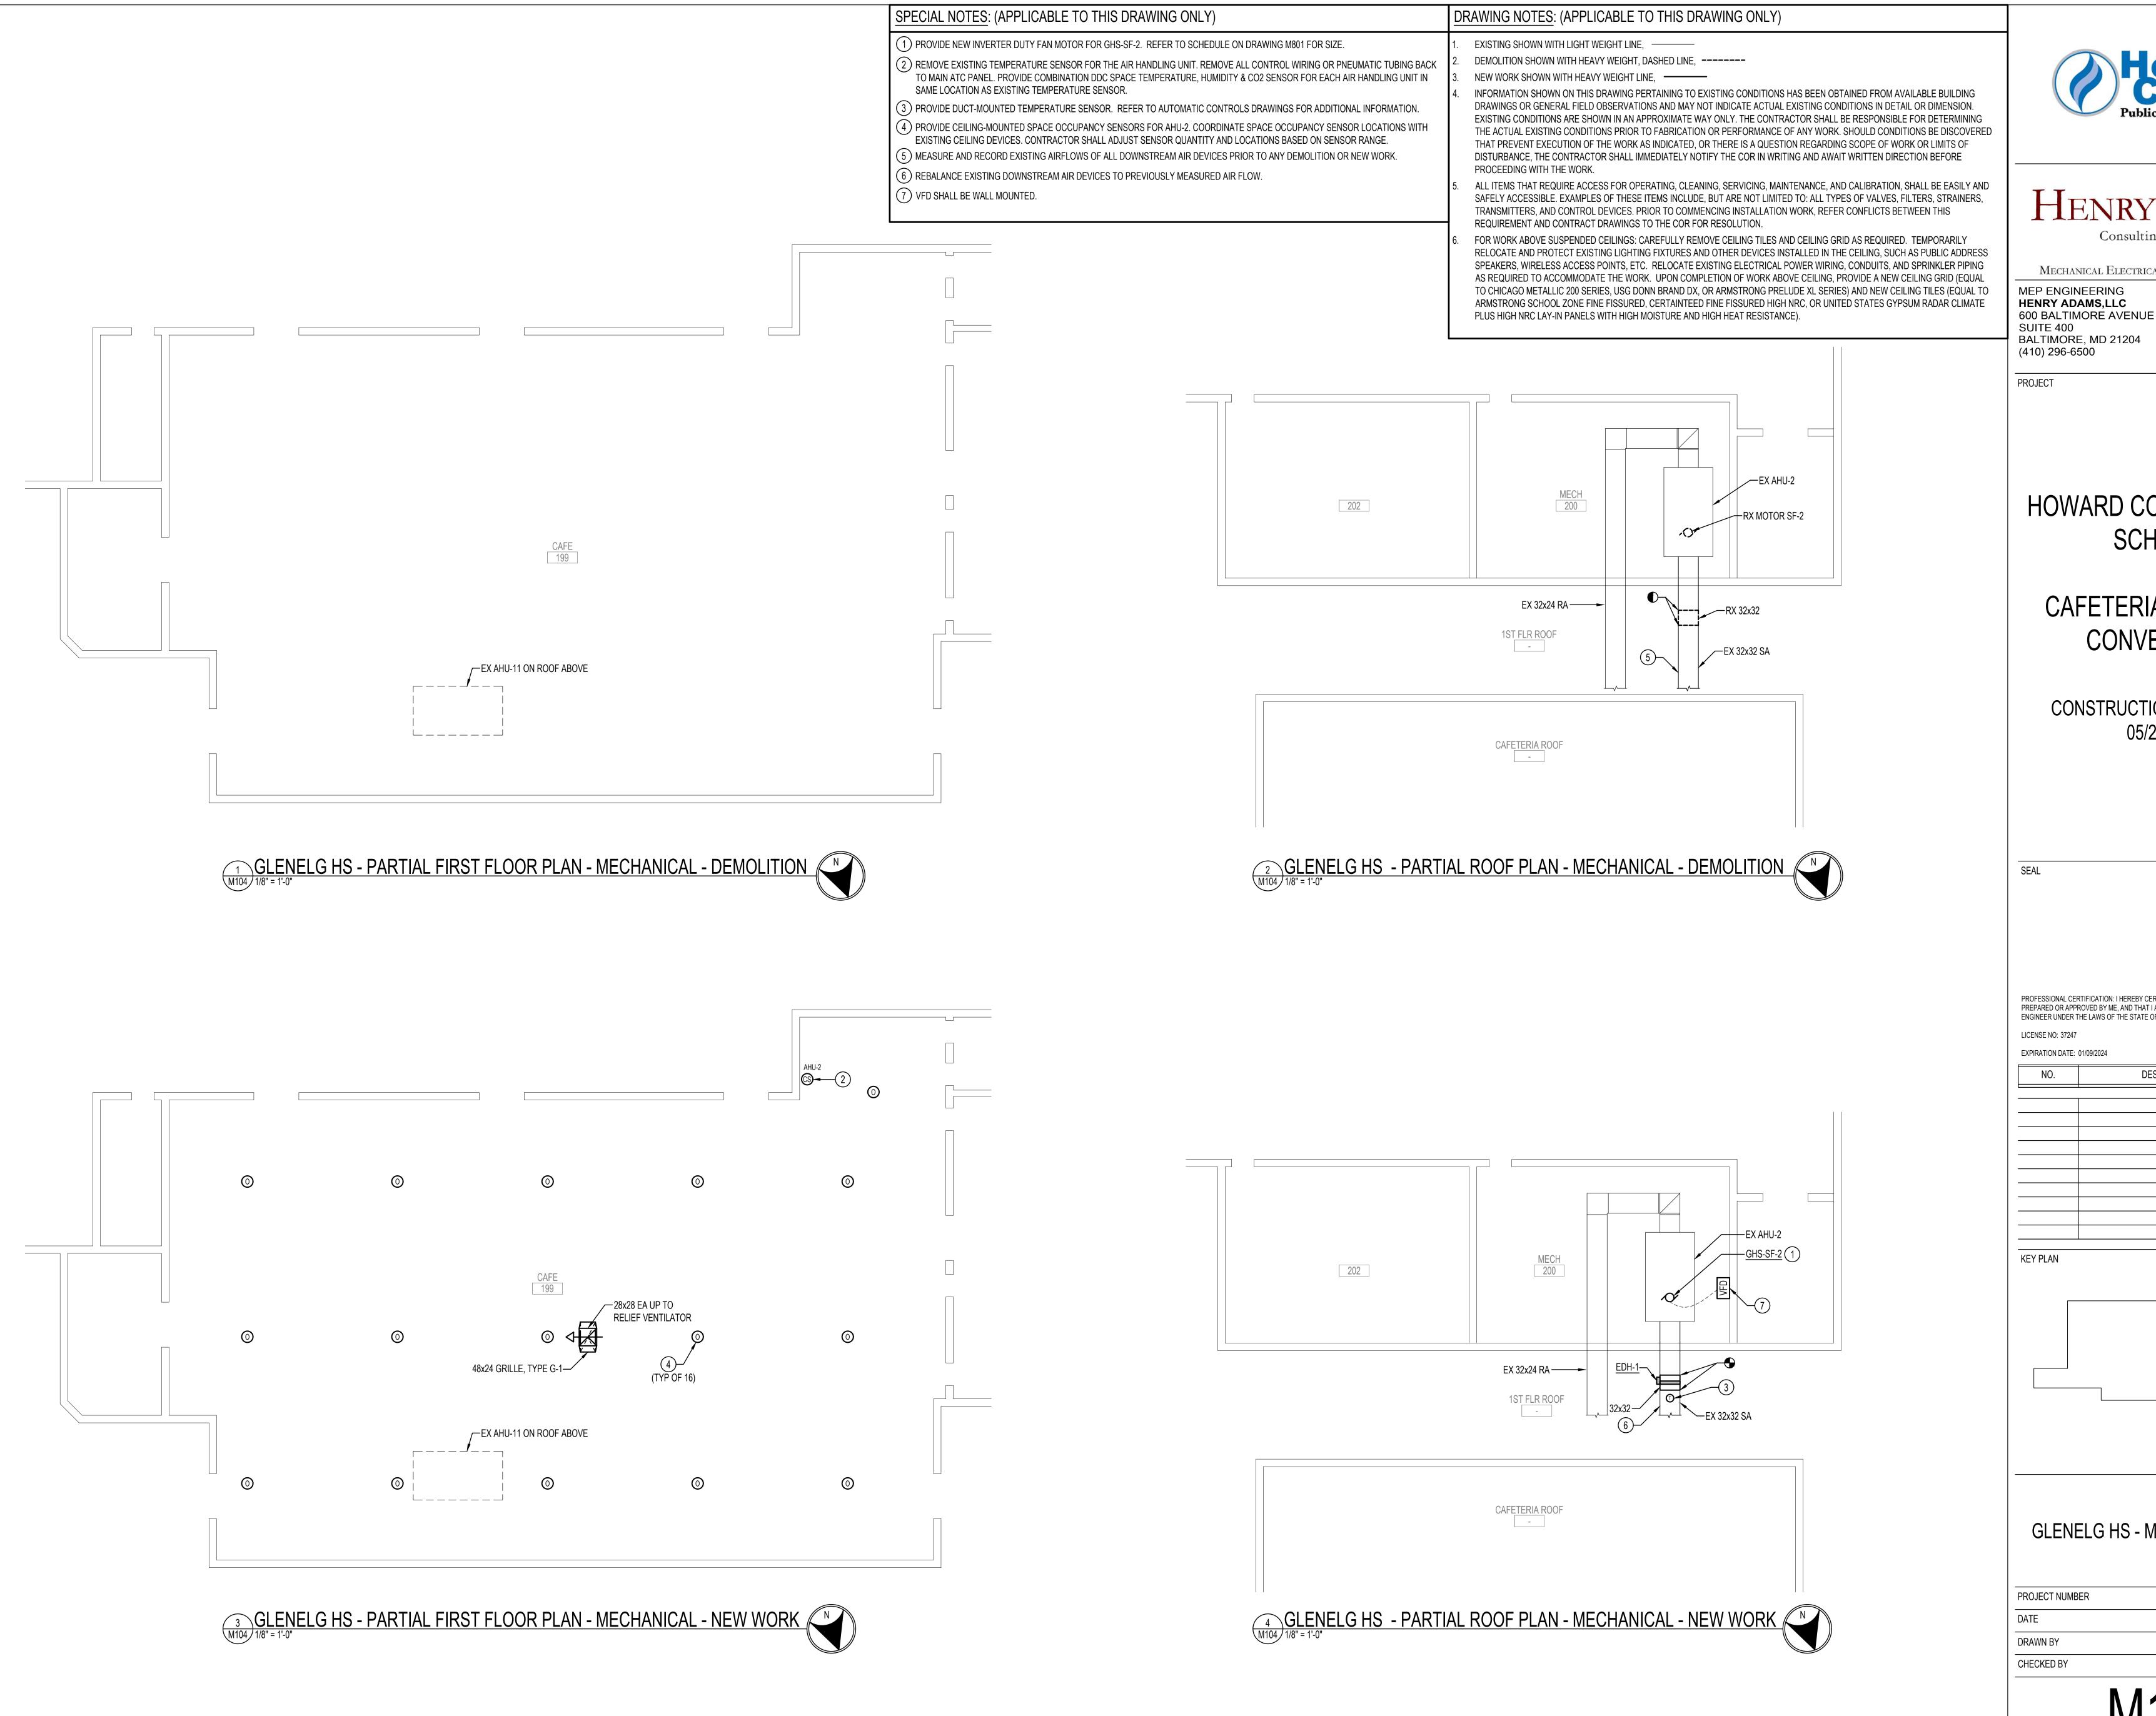





Consulting Engineers

MECHANICAL ELECTRICAL & PLUMBING ENGINEERS MEP ENGINEERING HENRY ADAMS,LLC

(410) 296-6500

HOWARD COUNTY PUBLIC SCHOOLS

CAFETERIA HVAC UNIT CONVERSIONS


CONSTRUCTION DOCUMENTS

PROFESSIONAL CERTIFICATION: I HEREBY CERTIFY THAT THESE DOCUMENTS WERE PREPARED OR APPROVED BY ME, AND THAT I AM A DULY LICENSED PROFESSIONAL ENGINEER UNDER THE LAWS OF THE STATE OF MARYLAND.

LICENSE NO: 37247

DESCRIPTION

KEY PLAN

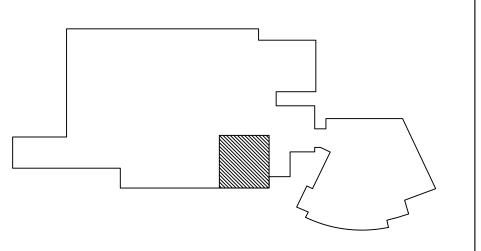

GLENELG HS - MECHANICAL WORK

PO-10028674 DRAWN BY CHECKED BY

M104

- 1) REMOVE EXISTING TEMPERATURE SENSOR FOR THE AIR HANDLING UNIT. REMOVE ALL CONTROL WIRING OR PNEUMATIC TUBING BACK TO MAIN ATC PANEL. PROVIDE COMBINATION DDC SPACE TEMPERATURE, HUMIDITY & CO2 SENSOR FOR EACH AIR HANDLING UNIT IN SAME LOCATION AS EXISTING TEMPERATURE SENSOR.
- 2) PROVIDE CEILING-MOUNTED SPACE OCCUPANCY SENSORS FOR AHU-3 AND ACU-3. COORDINATE SPACE OCCUPANCY SENSOR LOCATIONS WITH EXISTING CEILING DEVICES. CONTRACTOR SHALL ADJUST SENSOR QUANTITY AND LOCATIONS BASED ON SENSOR
- 3) MEASURE AND RECORD EXISTING AIRFLOWS OF ALL DOWNSTREAM AIR DEVICES PRIOR TO ANY DEMOLITION OR NEW WORK. 4) REBALANCE EXISTING DOWNSTREAM AIR DEVICES TO PREVIOUSLY MEASURED AIR FLOW.
- 5) BALANCE THE AIRFLOW FOR ALL AIR INLETS AND OUTLETS TO THE DESIGN AIRFLOW RATES SHOWN ON THE ORIGINAL BUILDING DRAWINGS. REFER TO DRAWING 4/M201 FOR THE DESIGN AIRFLOW RATES.

DRAWING NOTES: (APPLICABLE TO THIS DRAWING ONLY)

- EXISTING SHOWN WITH LIGHT WEIGHT LINE, ————
- DEMOLITION SHOWN WITH HEAVY WEIGHT, DASHED LINE, -----NEW WORK SHOWN WITH HEAVY WEIGHT LINE. ————
- THAT PREVENT EXECUTION OF THE WORK AS INDICATED, OR THERE IS A QUESTION REGARDING SCOPE OF WORK OR LIMITS OF PROCEEDING WITH THE WORK.
 - TRANSMITTERS, AND CONTROL DEVICES. PRIOR TO COMMENCING INSTALLATION WORK, REFER CONFLICTS BETWEEN THIS REQUIREMENT AND CONTRACT DRAWINGS TO THE COR FOR RESOLUTION
 - PLUS HIGH NRC LAY-IN PANELS WITH HIGH MOISTURE AND HIGH HEAT RESISTANCE).





MECHANICAL ELECTRICAL & PLUMBING ENGINEERS MEP ENGINEERING HENRY ADAMS,LLC

600 BALTIMORÉ AVENUE SUITE 400 BALTIMORE, MD 21204 (410) 296-6500

PROJECT

HOWARD COUNTY PUBLIC SCHOOLS

CAFETERIA HVAC UNIT CONVERSIONS

CONSTRUCTION DOCUMENTS


PROFESSIONAL CERTIFICATION: I HEREBY CERTIFY THAT THESE DOCUMENTS WERE PREPARED OR APPROVED BY ME, AND THAT I AM A DULY LICENSED PROFESSIONAL ENGINEER UNDER THE LAWS OF THE STATE OF MARYLAND.

LICENSE NO: 37247

EXPIRATION DATE: 01/09/2024

DESCRIPTION


KEY PLAN

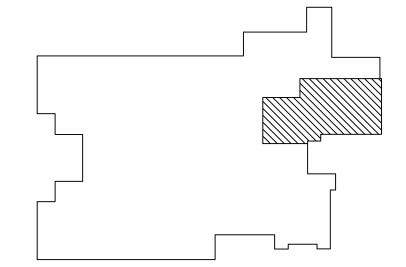

GORMAN CROSSING ES - MECHANICAL WORK


PO-10028674 05/25/2023 DRAWN BY CHECKED BY

M105

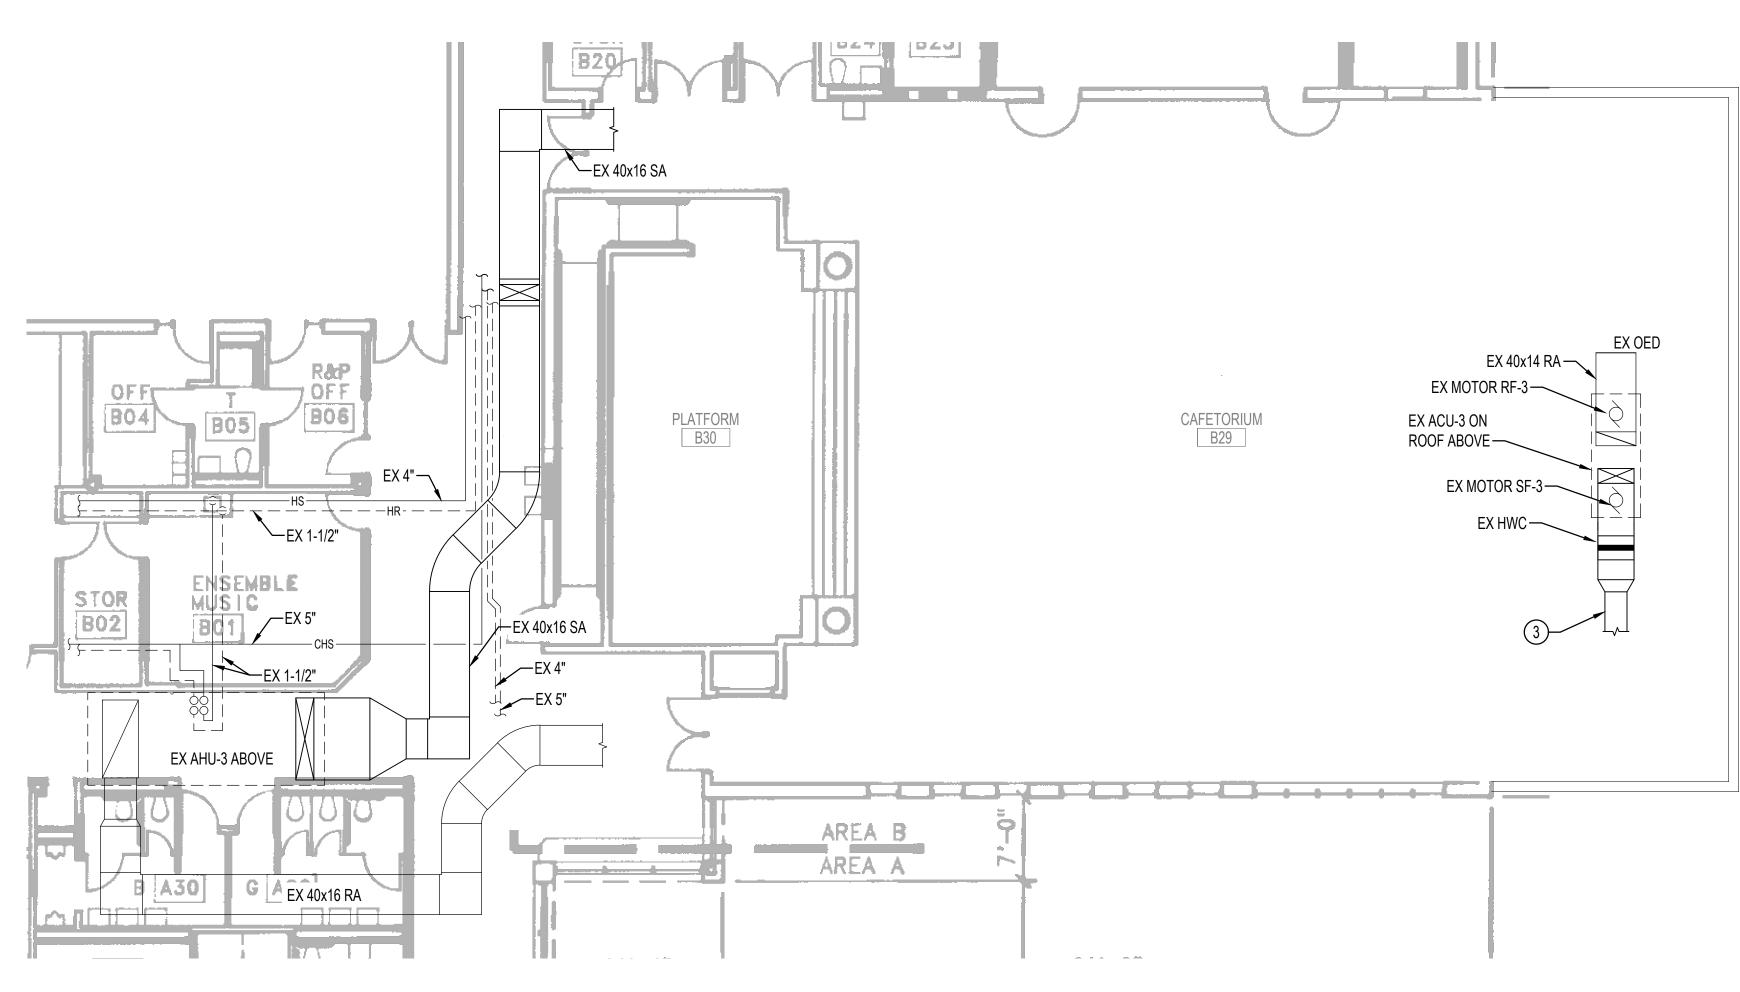

GORMAN CROSSING ES - PARTIAL FIRST FLOOR PLAN - MECHANICAL - EXISTING


NOTE: REFER TO AUTOMATIC CONTROLS FOR REQUIRED NEW WORK

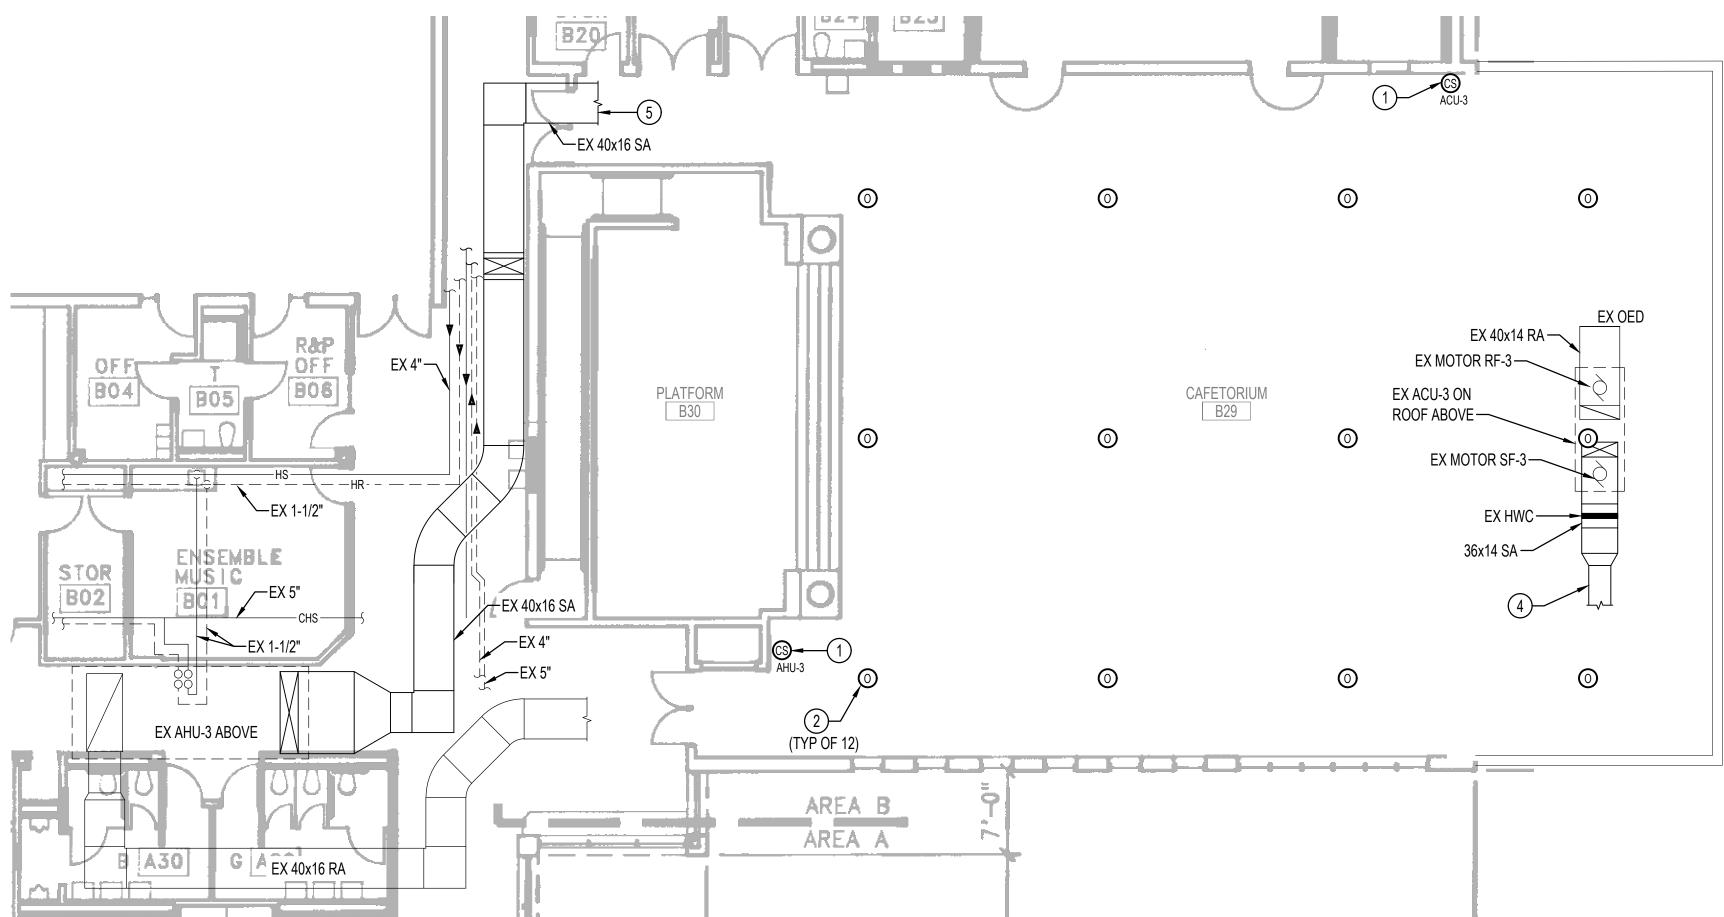



GORMAN CROSSING ES - PARTIAL FIRST FLOOR PLAN - MECHANICAL - NEW WORK

N

1/8" = 1'-0"

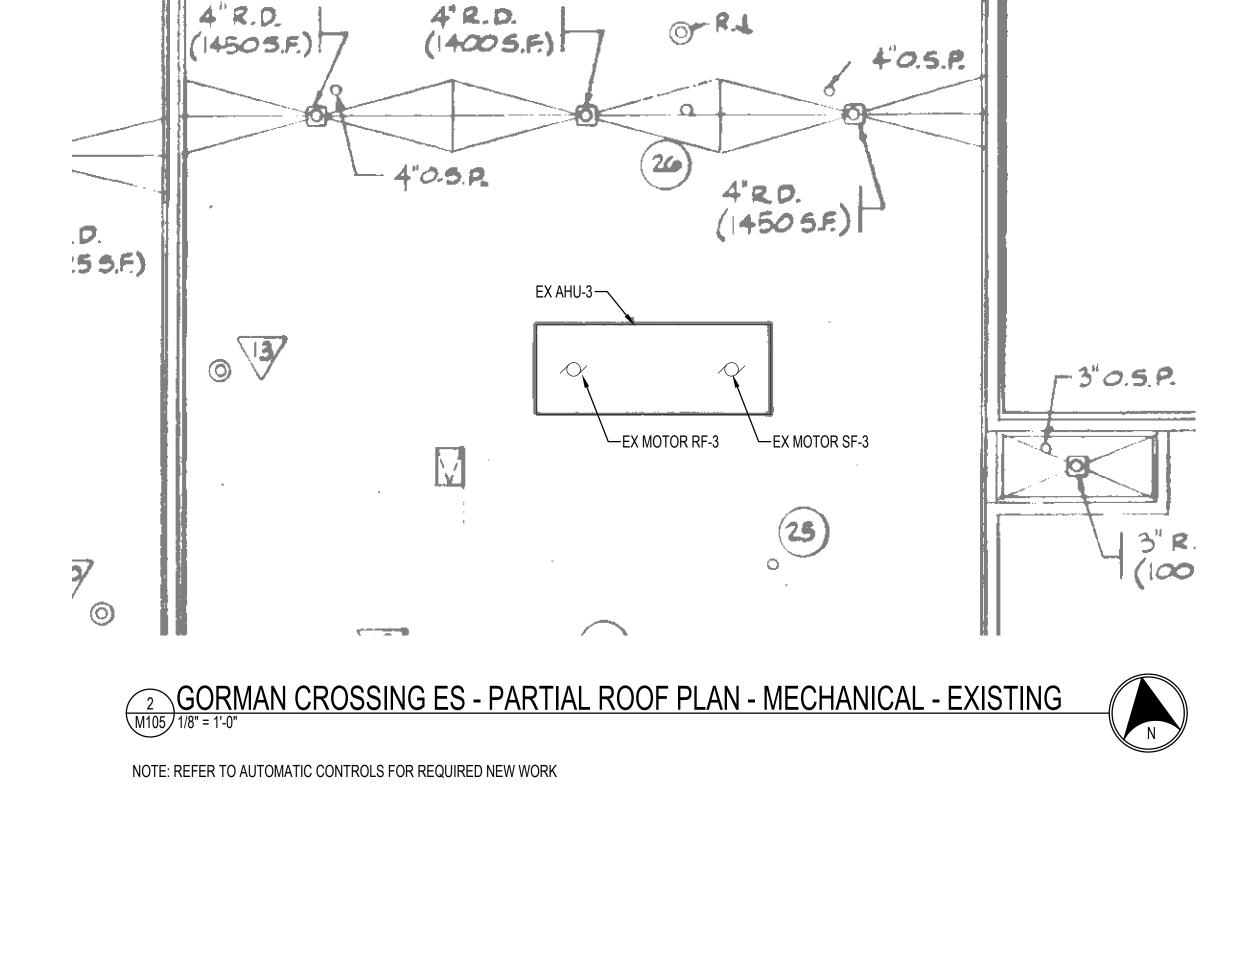

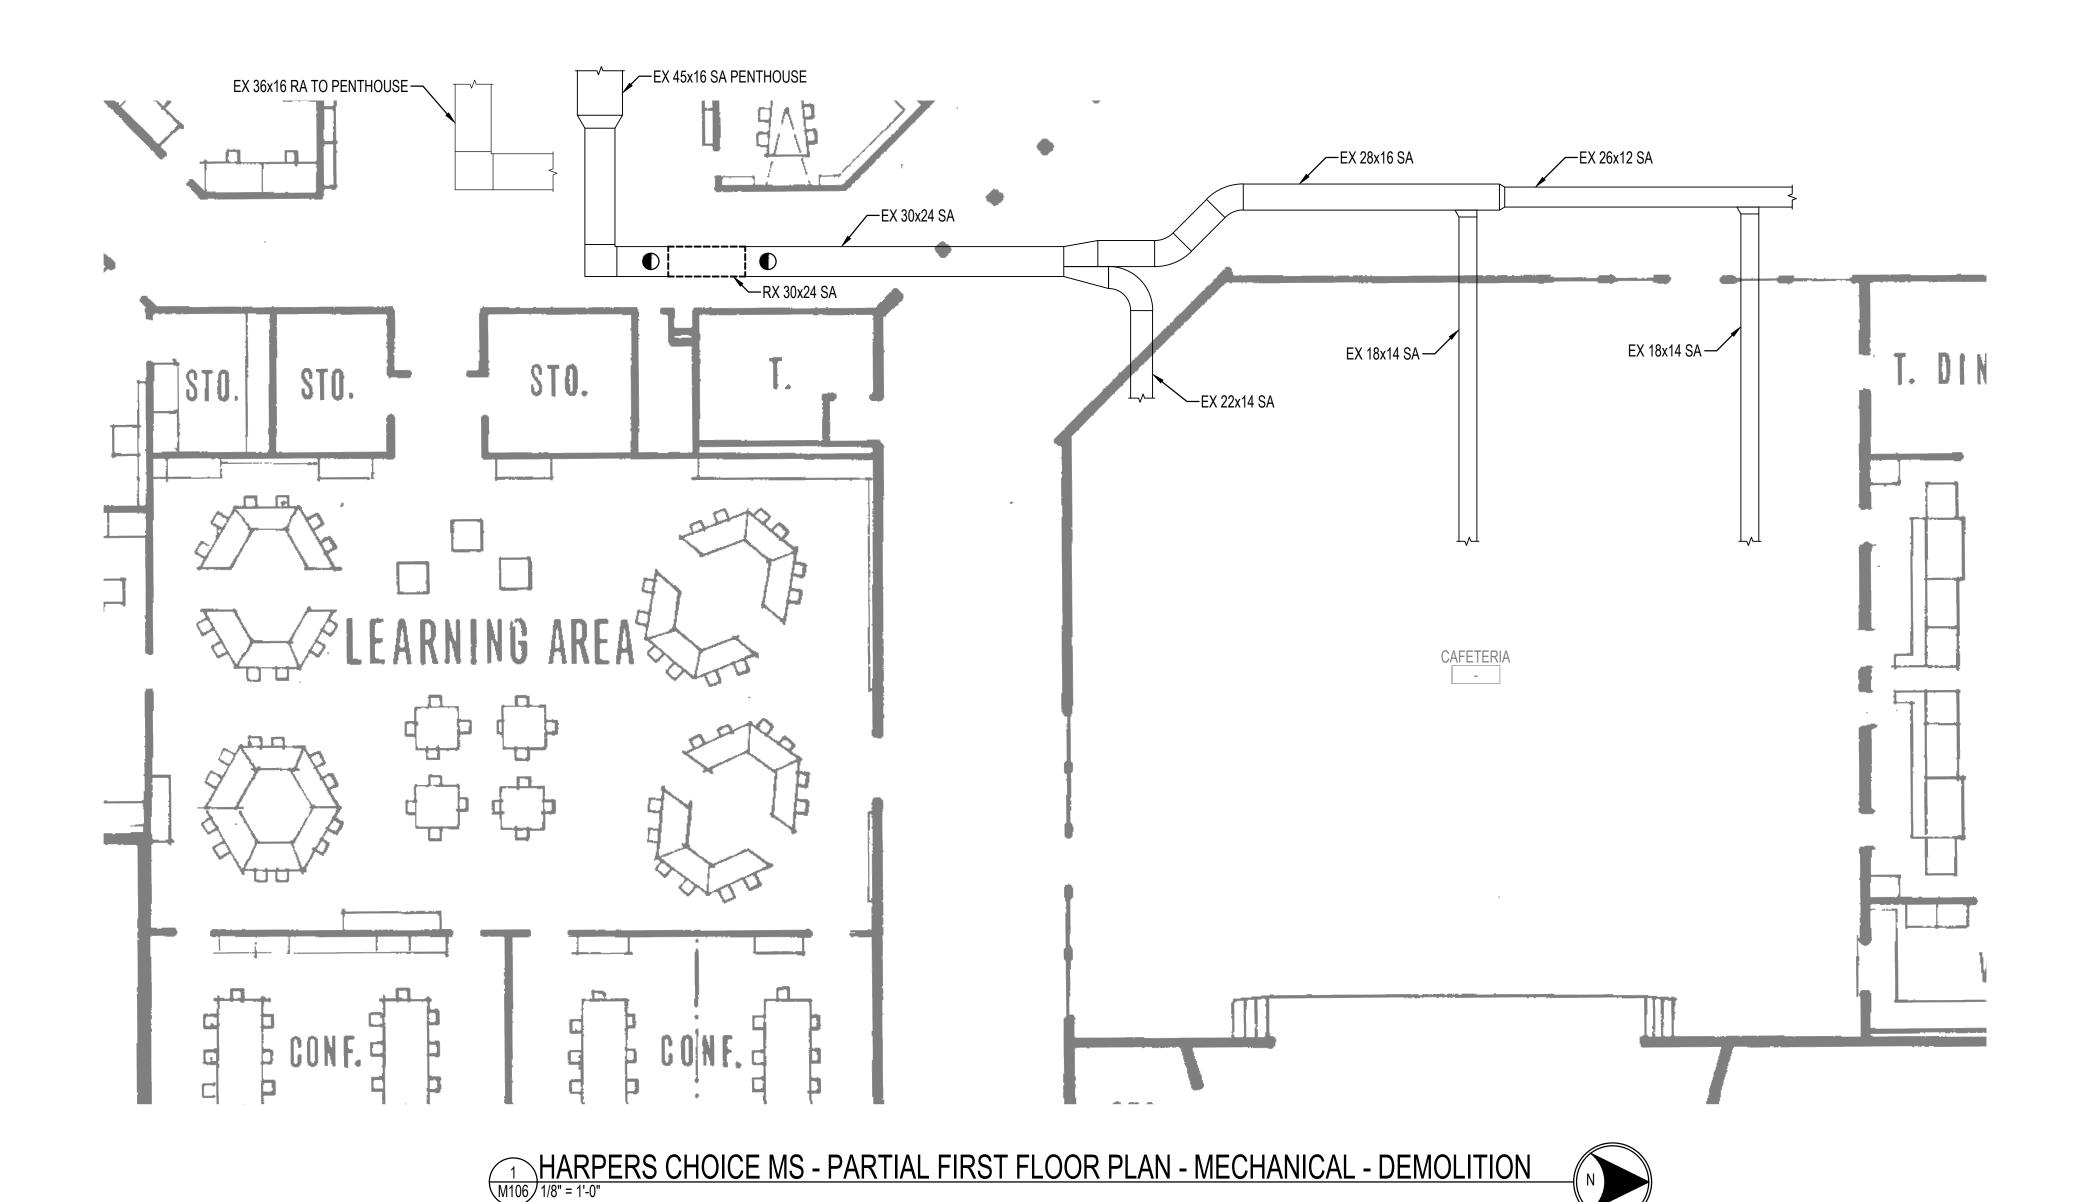

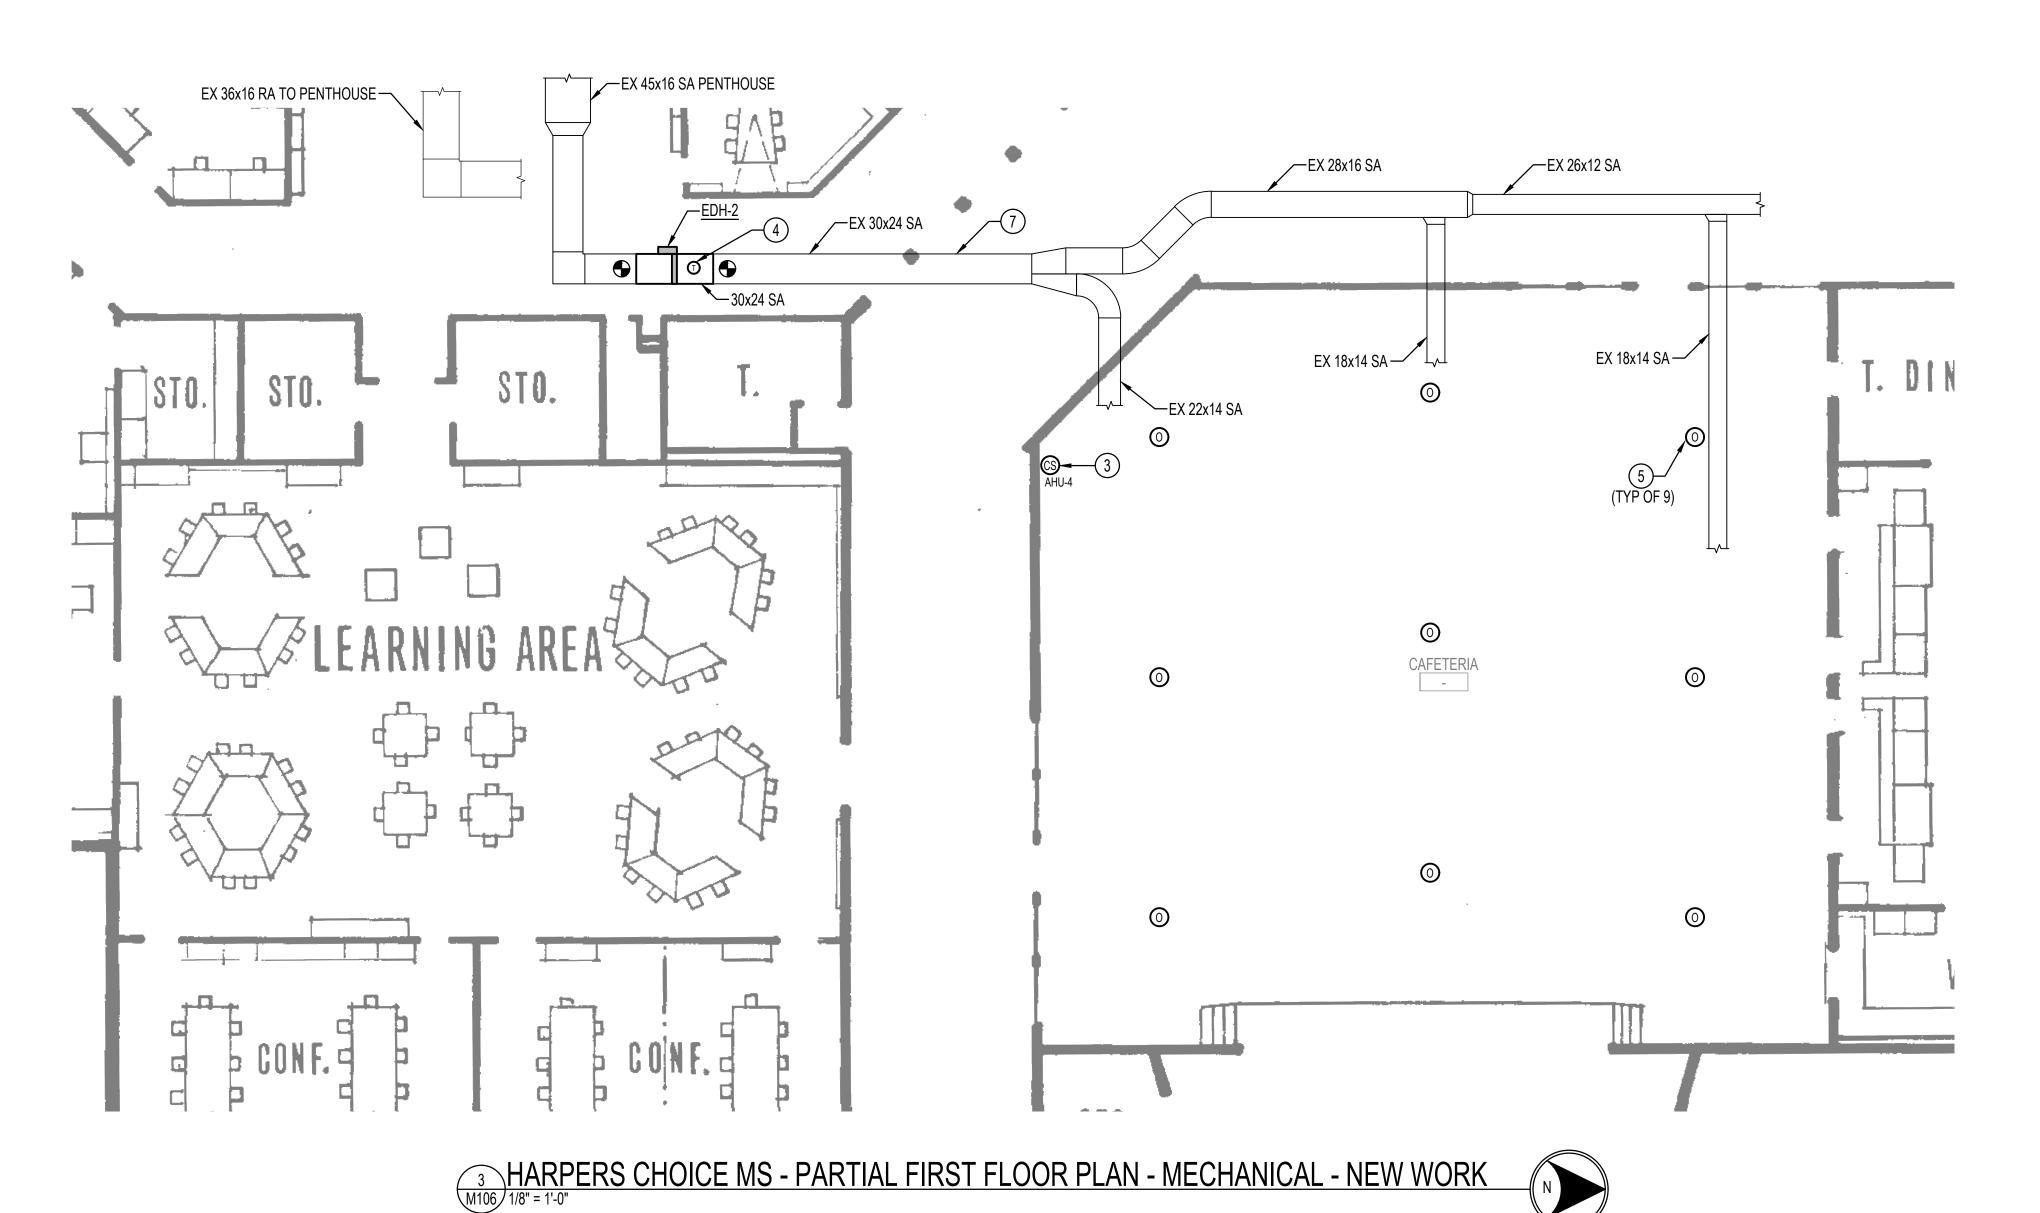


<u>DRAWING NOTES</u>: (APPLICABLE TO THIS DRAWING ONLY)


- EXISTING SHOWN WITH LIGHT WEIGHT LINE, ————
- DEMOLITION SHOWN WITH HEAVY WEIGHT, DASHED LINE, -----
- NEW WORK SHOWN WITH HEAVY WEIGHT LINE. ————
- THAT PREVENT EXECUTION OF THE WORK AS INDICATED, OR THERE IS A QUESTION REGARDING SCOPE OF WORK OR LIMITS OF DISTURBANCE, THE CONTRACTOR SHALL IMMEDIATELY NOTIFY THE COR IN WRITING AND AWAIT WRITTEN DIRECTION BEFORE PROCEEDING WITH THE WORK.
- ALL ITEMS THAT REQUIRE ACCESS FOR OPERATING, CLEANING, SERVICING, MAINTENANCE, AND CALIBRATION, SHALL BE EASILY AND TRANSMITTERS, AND CONTROL DEVICES. PRIOR TO COMMENCING INSTALLATION WORK, REFER CONFLICTS BETWEEN THIS REQUIREMENT AND CONTRACT DRAWINGS TO THE COR FOR RESOLUTION
- PLUS HIGH NRC LAY-IN PANELS WITH HIGH MOISTURE AND HIGH HEAT RESISTANCE).

SPECIAL NOTES: (APPLICABLE TO THIS DRAWING ONLY)


- 1) PROVIDE NEW INVERTER DUTY FAN MOTOR FOR HCMS-RF-3. REFER TO SCHEDULE ON DRAWING M801 FOR SIZE.
- 2 PROVIDE NEW INVERTER DUTY FAN MOTOR FOR HCMS-SF-3. REFER TO SCHEDULE ON DRAWING M801 FOR SIZE.
- 3) REMOVE EXISTING TEMPERATURE SENSOR FOR THE AIR HANDLING UNIT. REMOVE ALL CONTROL WIRING OR PNEUMATIC TUBING BACK TO MAIN ATC PANEL. PROVIDE COMBINATION DDC SPACE TEMPERATURE, HUMIDITY & CO2 SENSOR FOR EACH AIR HANDLING UNIT IN SAME LOCATION AS EXISTING TEMPERATURE SENSOR.
- 4) PROVIDE DUCT-MOUNTED TEMPERATURE SENSOR. REFER TO AUTOMATIC CONTROLS DRAWINGS FOR ADDITIONAL INFORMATION.
- 5) PROVIDE CEILING-MOUNTED SPACE OCCUPANCY SENSORS FOR AHU-3. COORDINATE SPACE OCCUPANCY SENSOR LOCATIONS WITH
- EXISTING CEILING DEVICES. CONTRACTOR SHALL ADJUST SENSOR QUANTITY AND LOCATIONS BASED ON SENSOR RANGE. (6) VFD SHALL BE WALL MOUNTED.
- 7) BALANCE THE AIRFLOW FOR ALL AIR INLETS AND OUTLETS TO THE DESIGN AIRFLOW RATES SHOWN ON THE ORIGINAL BUILDING DRAWINGS. REFER TO DRAWING 1/M202 FOR THE DESIGN AIRFLOW RATES.

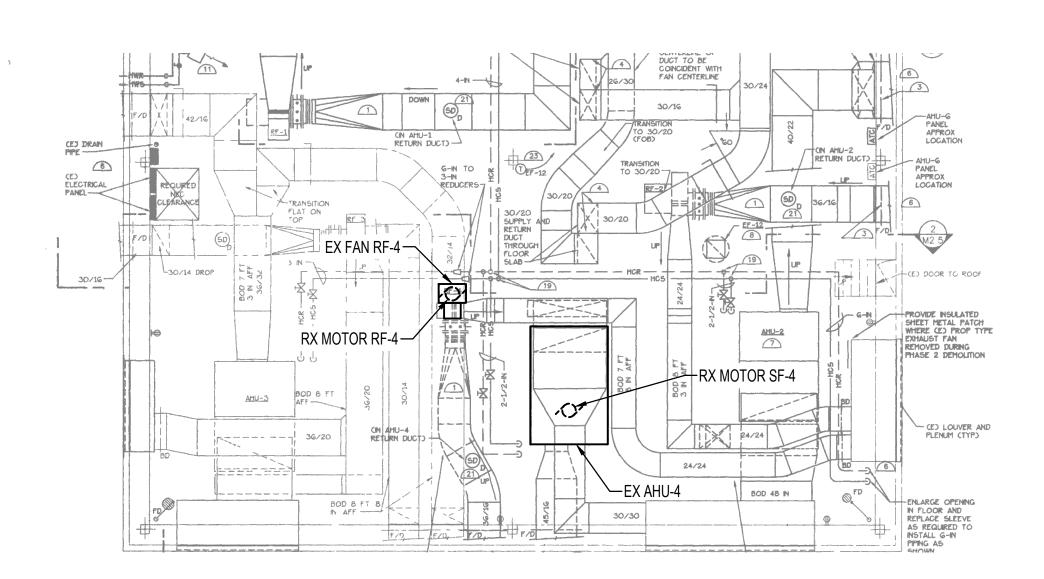



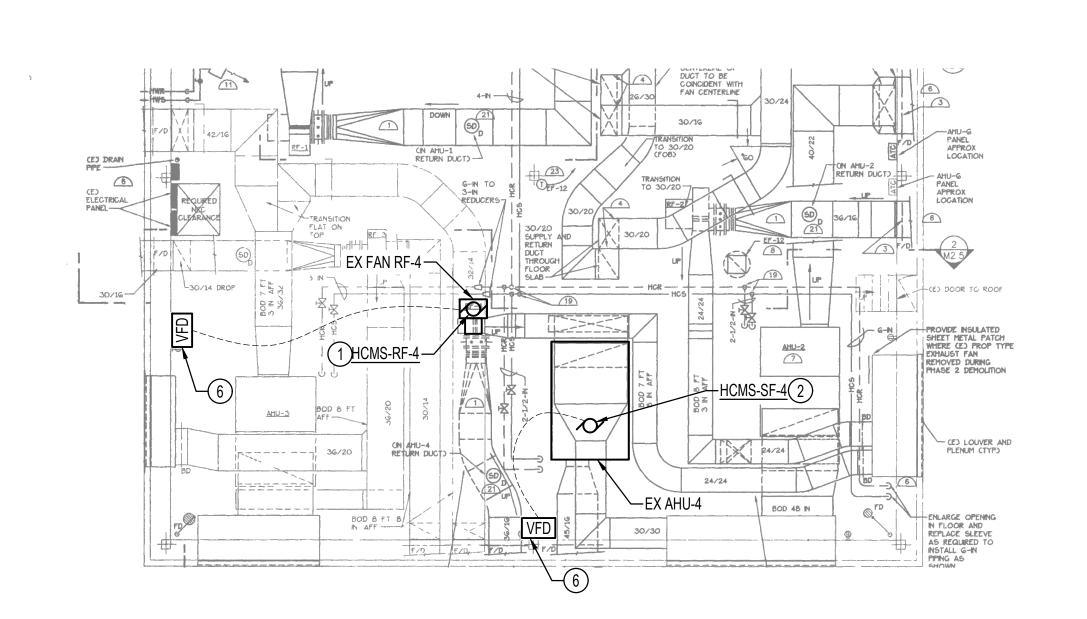

HARPERS CHOICE MS - PARTIAL PENTHOUSE PLAN - MECHANICAL - NEW WORK

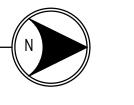



HENRY ADAMS Consulting Engineers

MECHANICAL ELECTRICAL & PLUMBING ENGINEERS

MEP ENGINEERING HENRY ADAMS,LLC 600 BALTIMORE AVENUE SUITE 400 BALTIMORE, MD 21204 (410) 296-6500


PROJECT

HOWARD COUNTY PUBLIC SCHOOLS

CAFETERIA HVAC UNIT CONVERSIONS

CONSTRUCTION DOCUMENTS

EXPIRATION DATE: 01/09/2024 DESCRIPTION

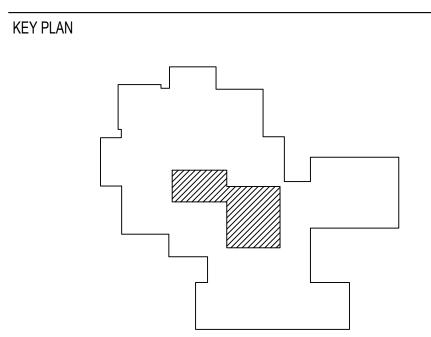

HARPERS CHOICE MS - MECHANICAL WORK

PROJECT NUMBER PO-10028674 05/25/2023 CHECKED BY

M106

- 1) PROVIDE NEW INVERTER DUTY FAN MOTOR FOR HSES-RF-3. REFER TO SCHEDULE ON DRAWING M801 FOR SIZE.
- 2) PROVIDE NEW INVERTER DUTY FAN MOTOR FOR HSES-SF-3. REFER TO SCHEDULE ON DRAWING M801 FOR SIZE..
- B) REMOVE EXISTING TEMPERATURE SENSOR FOR THE AIR HANDLING UNIT. REMOVE ALL CONTROL WIRING OR PNEUMATIC TUBING BACK SAME LOCATION AS EXISTING TEMPERATURE SENSOR.
- 4) PROVIDE DUCT-MOUNTED TEMPERATURE SENSOR. REFER TO AUTOMATIC CONTROLS DRAWINGS FOR ADDITIONAL INFORMATION
- 5) PROVIDE CEILING-MOUNTED SPACE OCCUPANCY SENSORS FOR AHU-3 AND ACU-2. COORDINATE SPACE OCCUPANCY SENSOR LOCATIONS WITH EXISTING CEILING DEVICES. CONTRACTOR SHALL ADJUST SENSOR QUANTITY AND LOCATIONS BASED ON SENSOR
- (6) PROVIDE VFD IN NEMA-3R ENCLOSURE. VFD SHALL BE MOUNTED ON UNITSTRUT FRAMING ON ROOF. UNITSTRUT FRAMING SHALL BE SUPPORTED BY EXISTING STRUCTURE.
- MEASURE AND RECORD EXISTING AIRFLOWS OF ALL DOWNSTREAM AIR DEVICES PRIOR TO ANY DEMOLITION OR NEW WORK.
- 8) REBALANCE EXISTING DOWNSTREAM AIR DEVICES TO PREVIOUSLY MEASURED AIR FLOW.
- B) BALANCE THE AIRFLOW FOR ALL AIR INLETS AND OUTLETS TO THE DESIGN AIRFLOW RATES SHOWN ON THE ORIGINAL BUILDING DRAWINGS. REFER TO DRAWING 2/M202 FOR THE DESIGN AIRFLOW RATES.

- EXISTING SHOWN WITH LIGHT WEIGHT LINE, ————
- DEMOLITION SHOWN WITH HEAVY WEIGHT, DASHED LINE, -----
- NEW WORK SHOWN WITH HEAVY WEIGHT LINE. ————

DRAWING NOTES: (APPLICABLE TO THIS DRAWING ONLY)

- THAT PREVENT EXECUTION OF THE WORK AS INDICATED, OR THERE IS A QUESTION REGARDING SCOPE OF WORK OR LIMITS OF DISTURBANCE, THE CONTRACTOR SHALL IMMEDIATELY NOTIFY THE COR IN WRITING AND AWAIT WRITTEN DIRECTION BEFORE PROCEEDING WITH THE WORK.
 - REQUIREMENT AND CONTRACT DRAWINGS TO THE COR FOR RESOLUTION
 - PLUS HIGH NRC LAY-IN PANELS WITH HIGH MOISTURE AND HIGH HEAT RESISTANCE).





MECHANICAL ELECTRICAL & PLUMBING ENGINEERS

MEP ENGINEERING HENRY ADAMS,LLC 600 BALTIMORE AVENUE SUITE 400 BALTIMORE, MD 21204 (410) 296-6500

PROJECT

HOWARD COUNTY PUBLIC SCHOOLS

CAFETERIA HVAC UNIT CONVERSIONS


CONSTRUCTION DOCUMENTS

PROFESSIONAL CERTIFICATION: I HEREBY CERTIFY THAT THESE DOCUMENTS WERE PREPARED OR APPROVED BY ME, AND THAT I AM A DULY LICENSED PROFESSIONAL

LICENSE NO: 37247 EXPIRATION DATE: 01/09/2024

NO.	DESCRIPTION	DATE




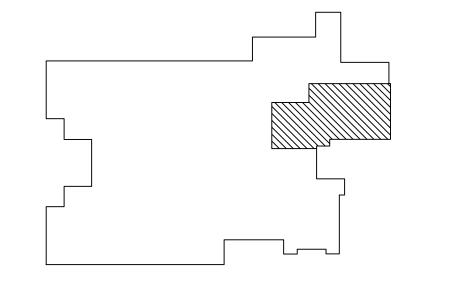


HOLLIFIELD STATION ES - MECHANICAL WORK


PROJECT NUMBER	PO-10028674
DATE	05/25/2023
DRAWN BY	NCV
CHECKED BY	BMB

M107

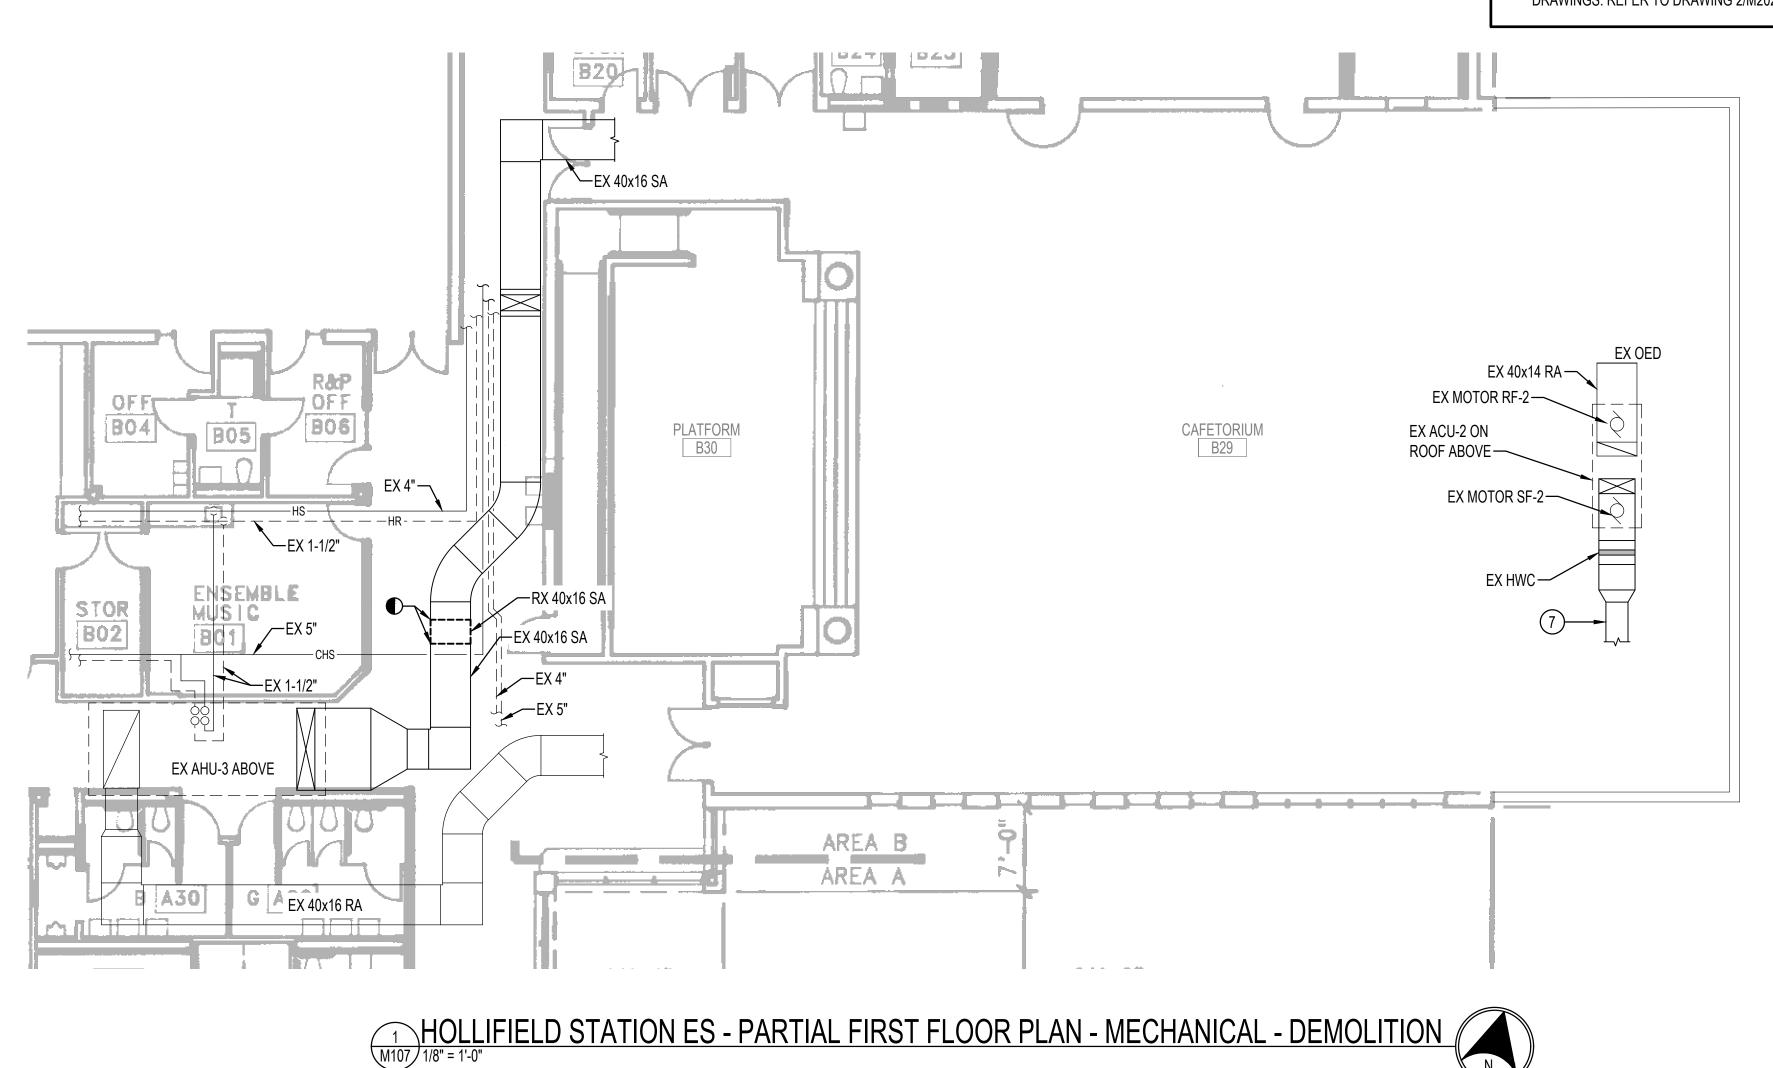


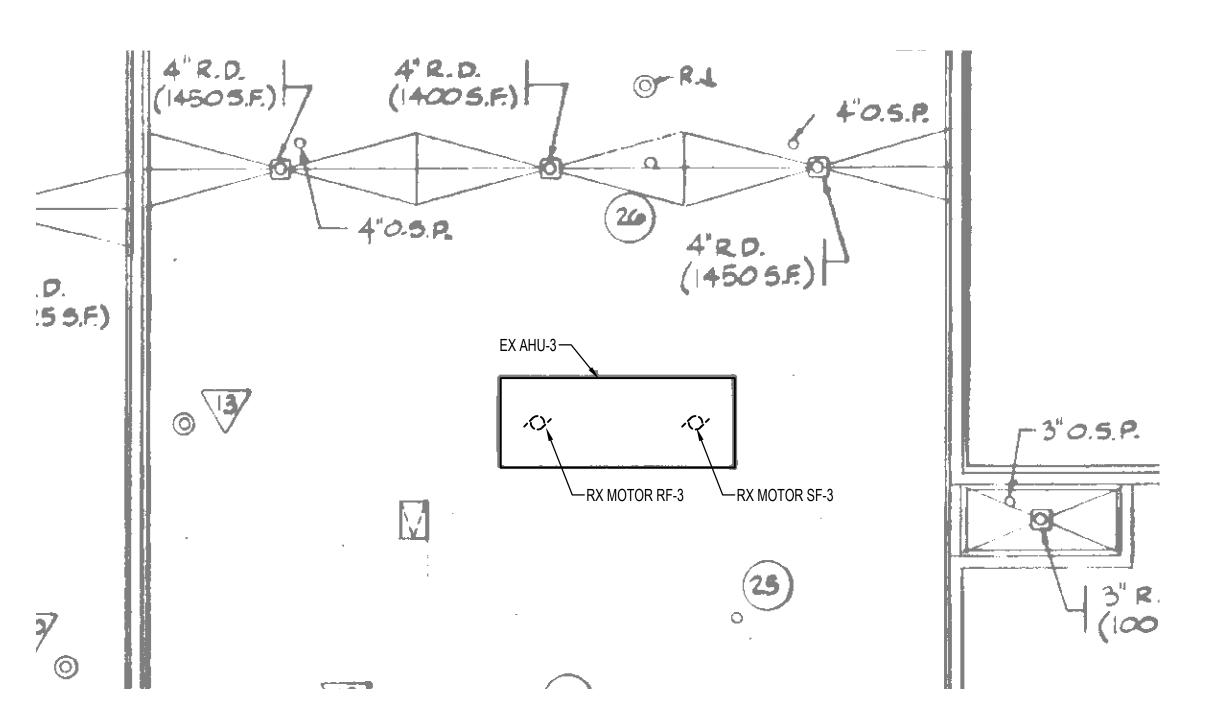

HOLLIFIELD STATION ES - PARTIAL ROOF PLAN - MECHANICAL - DEMOLITION

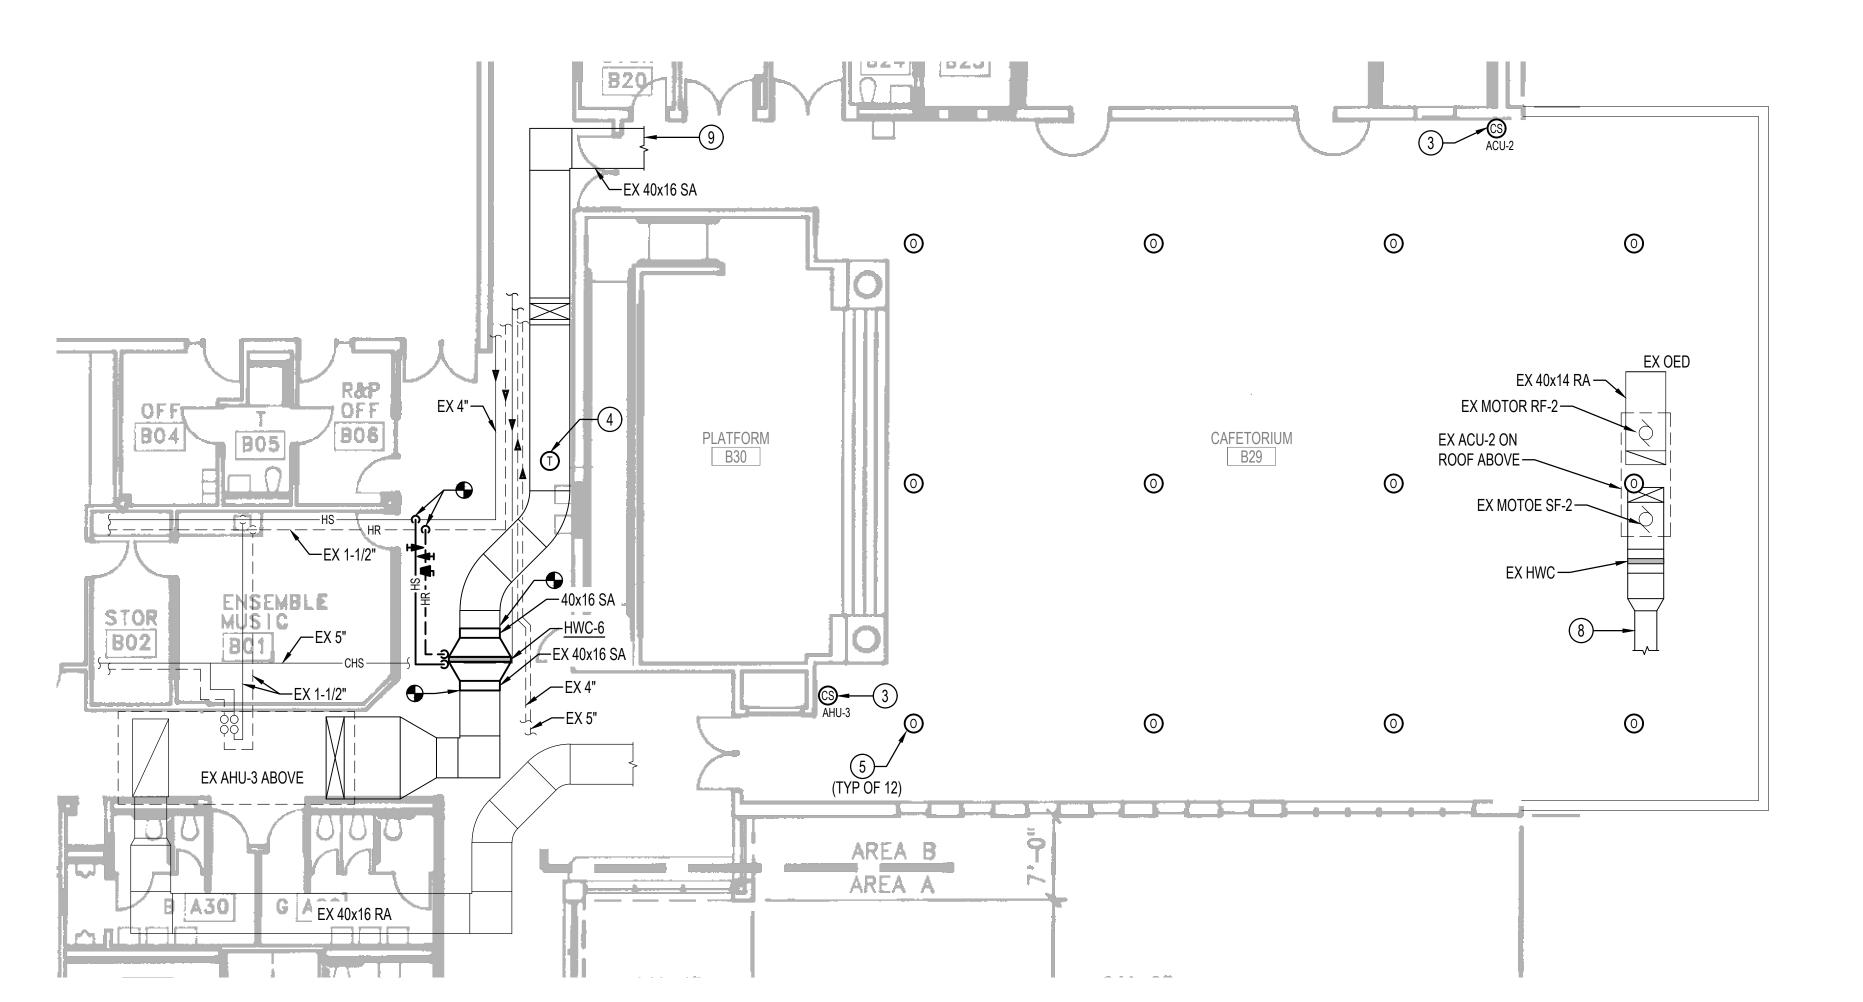


3 HOLLIFIELD STATION ES - PARTIAL FIRST FLOOR PLAN - MECHANICAL - NEW WORK
M107 1/8" = 1'-0"

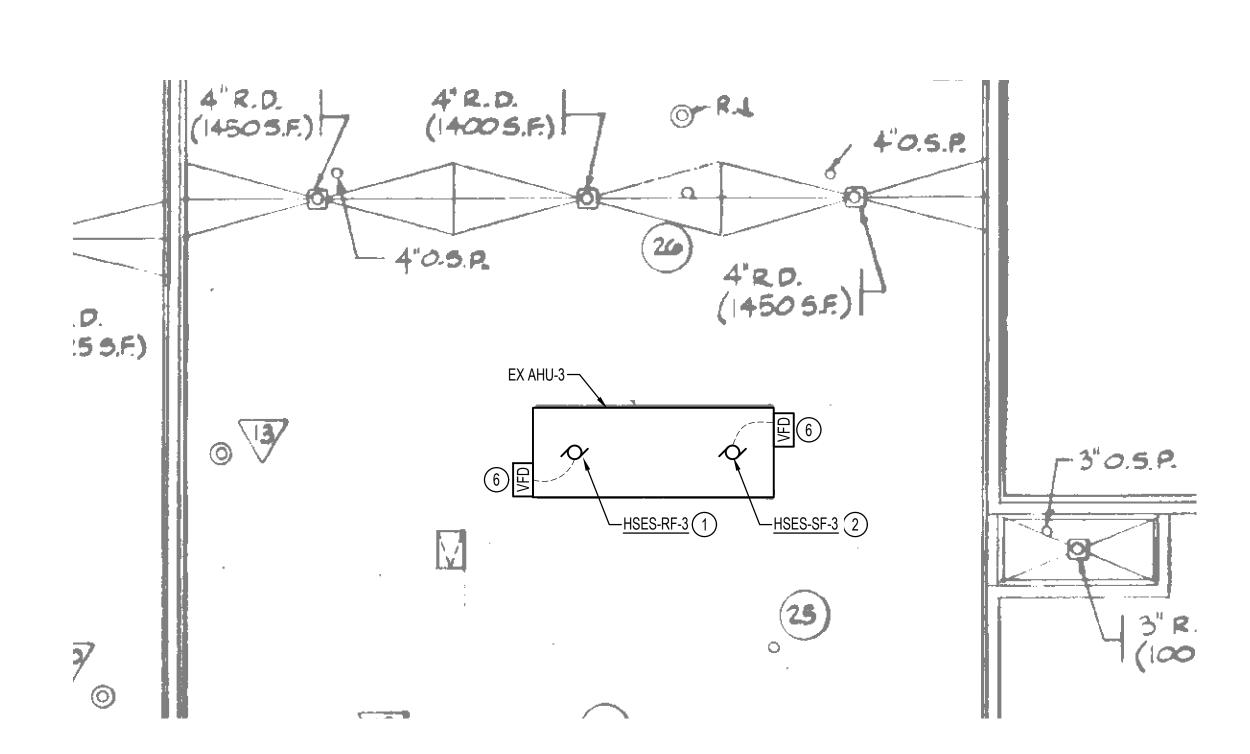


4 HOLLIFIELD STATION ES - PARTIAL ROOF PLAN - MECHANICAL - NEW WORK

M107 1/8" = 1'-0"



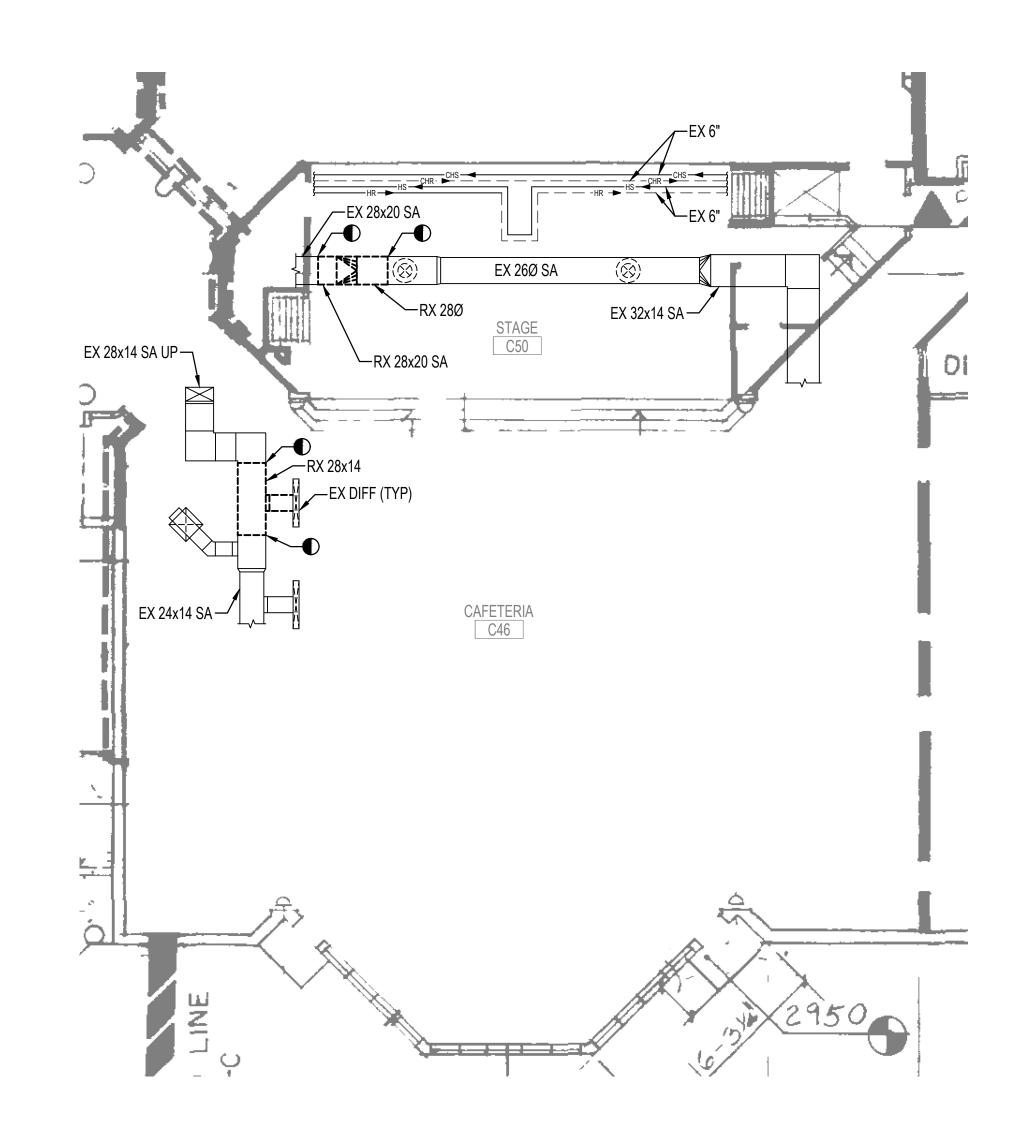

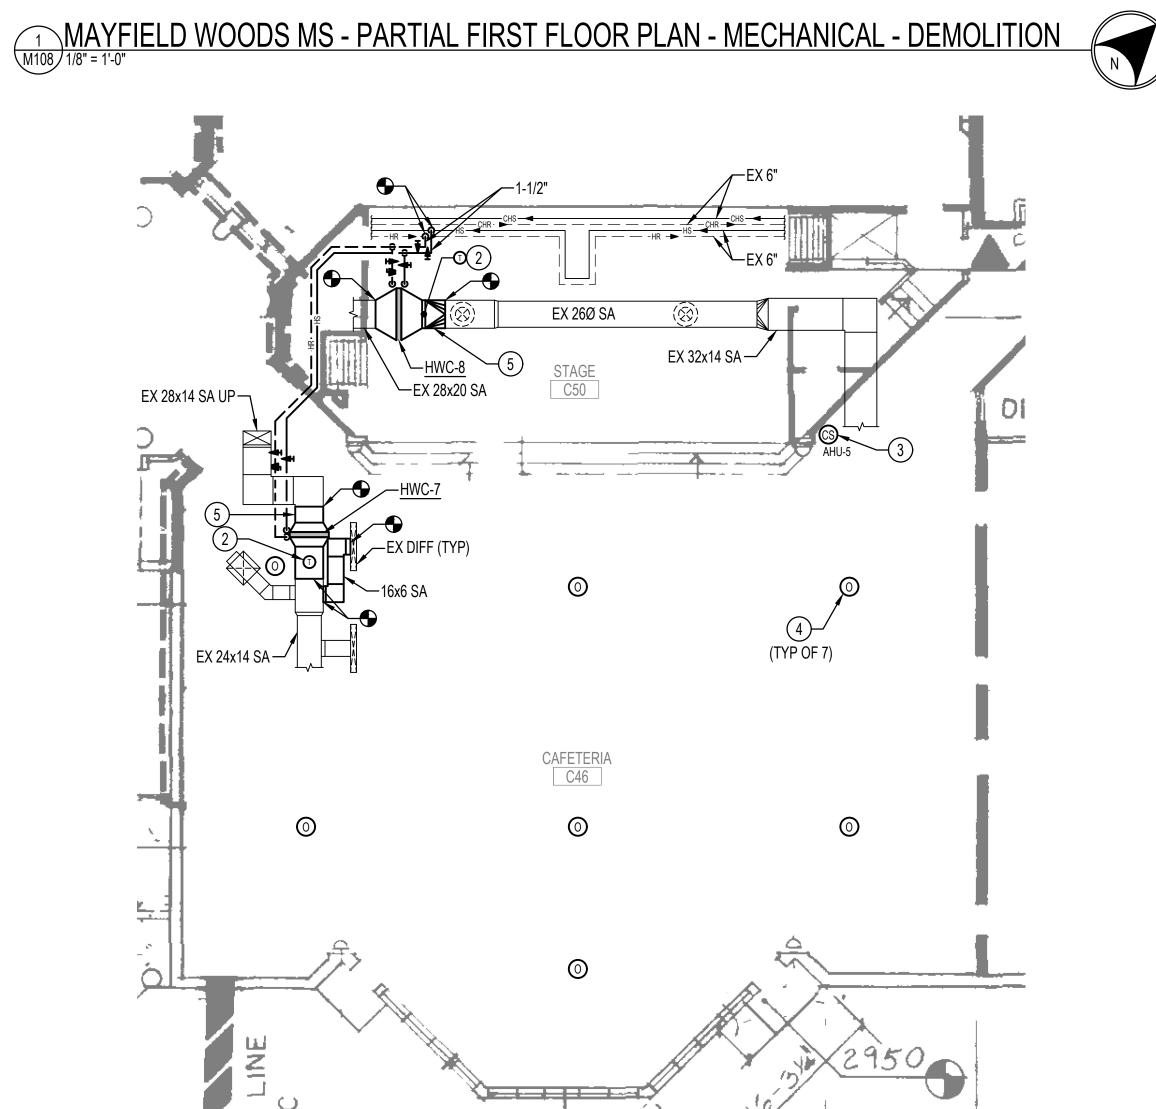

MAYFIELD WOODS MS - PARTIAL FIRST FLOOR PLAN - MECHANICAL - NEW WORK

M108 1/8" = 1'-0"

SPECIAL NOTES: (APPLICABLE TO THIS DRAWING ONLY)

1) PROVIDE NEW INVERTER DUTY FAN MOTOR FOR MWMS-SF-5. REFER TO SCHEDULE ON DRAWING M801 FOR SIZE.

2) PROVIDE DUCT-MOUNTED TEMPERATURE SENSOR. REFER TO AUTOMATIC CONTROLS DRAWINGS FOR ADDITIONAL INFORMATION.

REMOVE EXISTING TEMPERATURE SENSOR FOR THE AIR HANDLING UNIT. REMOVE ALL CONTROL WIRING OR PNEUMATIC TUBING BACK TO MAIN ATC PANEL. PROVIDE COMBINATION DDC SPACE TEMPERATURE, HUMIDITY & CO2 SENSOR FOR EACH AIR HANDLING UNIT IN SAME LOCATION AS EXISTING TEMPERATURE SENSOR.

4) PROVIDE CEILING-MOUNTED SPACE OCCUPANCY SENSORS FOR AHU-3. COORDINATE SPACE OCCUPANCY SENSOR LOCATIONS WITH EXISTING CEILING DEVICES. CONTRACTOR SHALL ADJUST SENSOR QUANTITY AND LOCATIONS BASED ON SENSOR RANGE.

5) BALANCE THE AIRFLOW FOR ALL AIR INLETS AND OUTLETS TO THE DESIGN AIRFLOW RATES SHOWN ON THE ORIGINAL BUILDING DRAWINGS. REFER TO DRAWING 3/M202 FOR THE DESIGN AIRFLOW RATES.

(6) VFD SHALL BE WALL MOUNTED.

DRAWING NOTES: (APPLICABLE TO THIS DRAWING ONLY)

- EXISTING SHOWN WITH LIGHT WEIGHT LINE, ————
- DEMOLITION SHOWN WITH HEAVY WEIGHT, DASHED LINE, -----
- NEW WORK SHOWN WITH HEAVY WEIGHT LINE, ———
- EXISTING CONDITIONS ARE SHOWN IN AN APPROXIMATE WAY ONLY. THE CONTRACTOR SHALL BE RESPONSIBLE FOR DETERMINING THE ACTUAL EXISTING CONDITIONS PRIOR TO FABRICATION OR PERFORMANCE OF ANY WORK. SHOULD CONDITIONS BE DISCOVERED THAT PREVENT EXECUTION OF THE WORK AS INDICATED, OR THERE IS A QUESTION REGARDING SCOPE OF WORK OR LIMITS OF DISTURBANCE, THE CONTRACTOR SHALL IMMEDIATELY NOTIFY THE COR IN WRITING AND AWAIT WRITTEN DIRECTION BEFORE PROCEEDING WITH THE WORK.
- ALL ITEMS THAT REQUIRE ACCESS FOR OPERATING, CLEANING, SERVICING, MAINTENANCE, AND CALIBRATION, SHALL BE EASILY AND SAFELY ACCESSIBLE. EXAMPLES OF THESE ITEMS INCLUDE, BUT ARE NOT LIMITED TO: ALL TYPES OF VALVES, FILTERS, STRAINERS, TRANSMITTERS, AND CONTROL DEVICES. PRIOR TO COMMENCING INSTALLATION WORK, REFER CONFLICTS BETWEEN THIS REQUIREMENT AND CONTRACT DRAWINGS TO THE COR FOR RESOLUTION.
- FOR WORK ABOVE SUSPENDED CEILINGS: CAREFULLY REMOVE CEILING TILES AND CEILING GRID AS REQUIRED. TEMPORARILY PLUS HIGH NRC LAY-IN PANELS WITH HIGH MOISTURE AND HIGH HEAT RESISTANCE).





MECHANICAL ELECTRICAL & PLUMBING ENGINEERS

MEP ENGINEERING **HENRY ADAMS,LLC** 600 BALTIMORE AVENUE SUITE 400 BALTIMORE, MD 21204 (410) 296-6500

PROJECT

HOWARD COUNTY PUBLIC SCHOOLS

CAFETERIA HVAC UNIT CONVERSIONS


CONSTRUCTION DOCUMENTS

PROFESSIONAL CERTIFICATION: I HEREBY CERTIFY THAT THESE DOCUMENTS WERE PREPARED OR APPROVED BY ME, AND THAT I AM A DULY LICENSED PROFESSIONAL ENGINEER UNDER THE LAWS OF THE STATE OF MARYLAND.

LICENSE NO: 37247

EXPIRATION DATE: 01/09/2024			
	NO.	DESCRIPTION	DATE
			ĺ


KEY PLAN

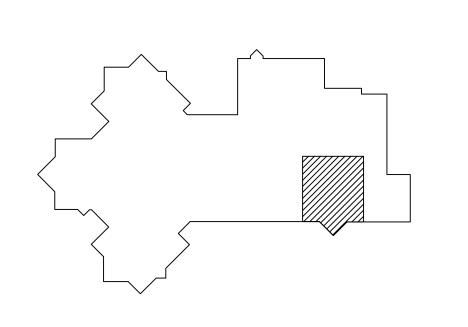

MAYFIELD WOODS MS - MECHANICAL WORK

PROJECT NUMBER	PO-10028674
DATE	05/25/2023
DRAWN BY	NCV
CHECKED BY	BMB


M108

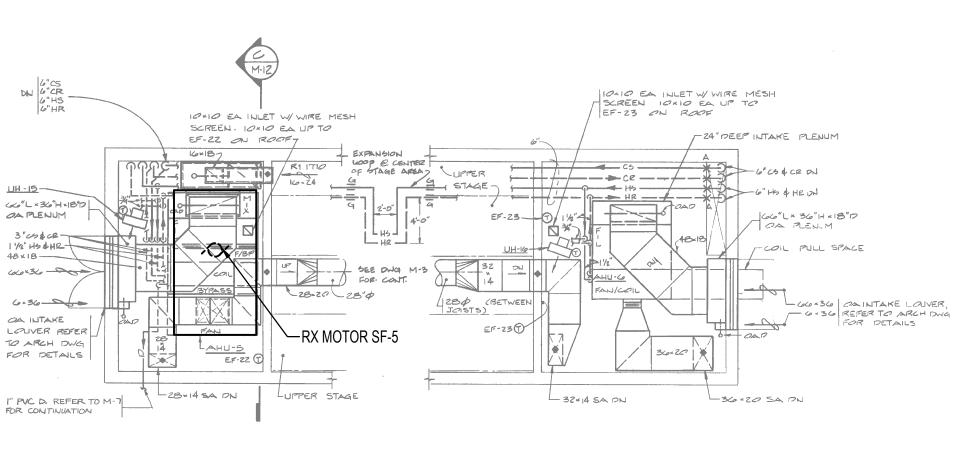





MAYFIELD WOODS MS - PARTIAL ROOF PLAN - MECHANICAL - DEMOLITION

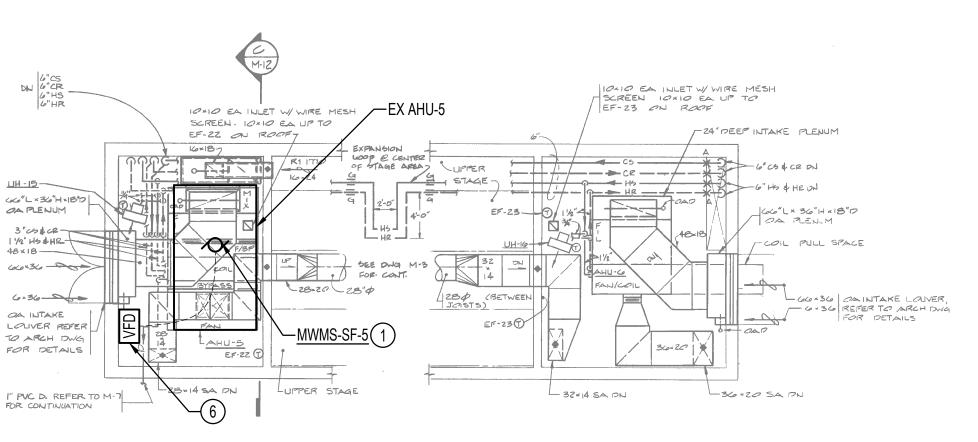







MAYFIELD WOODS MS - PARTIAL ROOF PLAN - MECHANICAL - NEW WORK



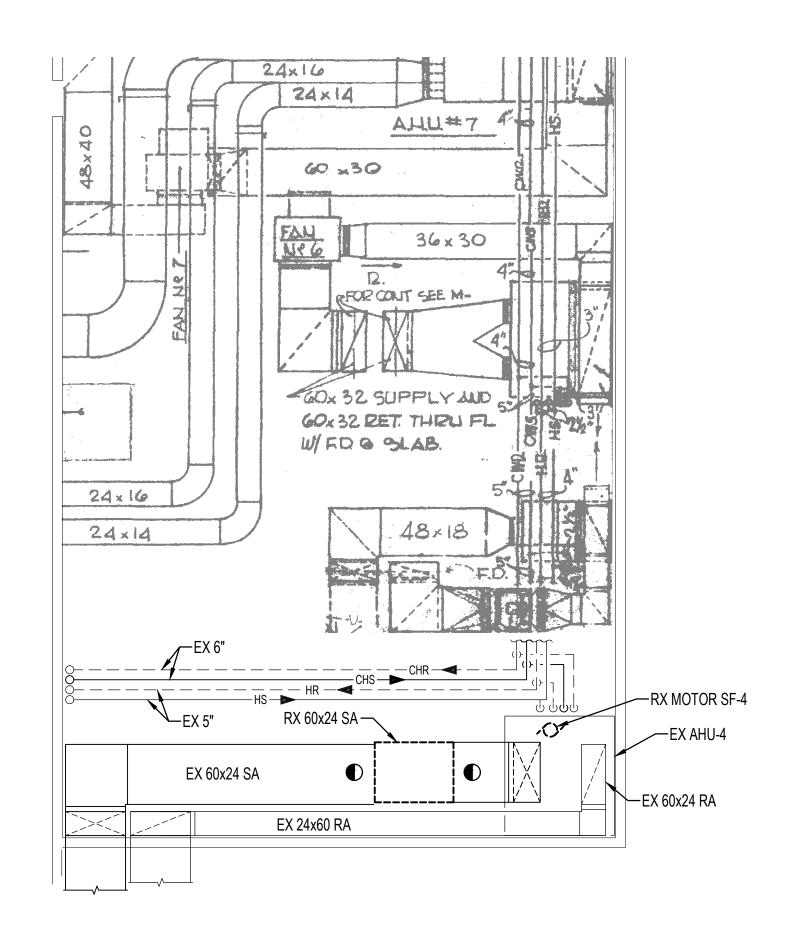



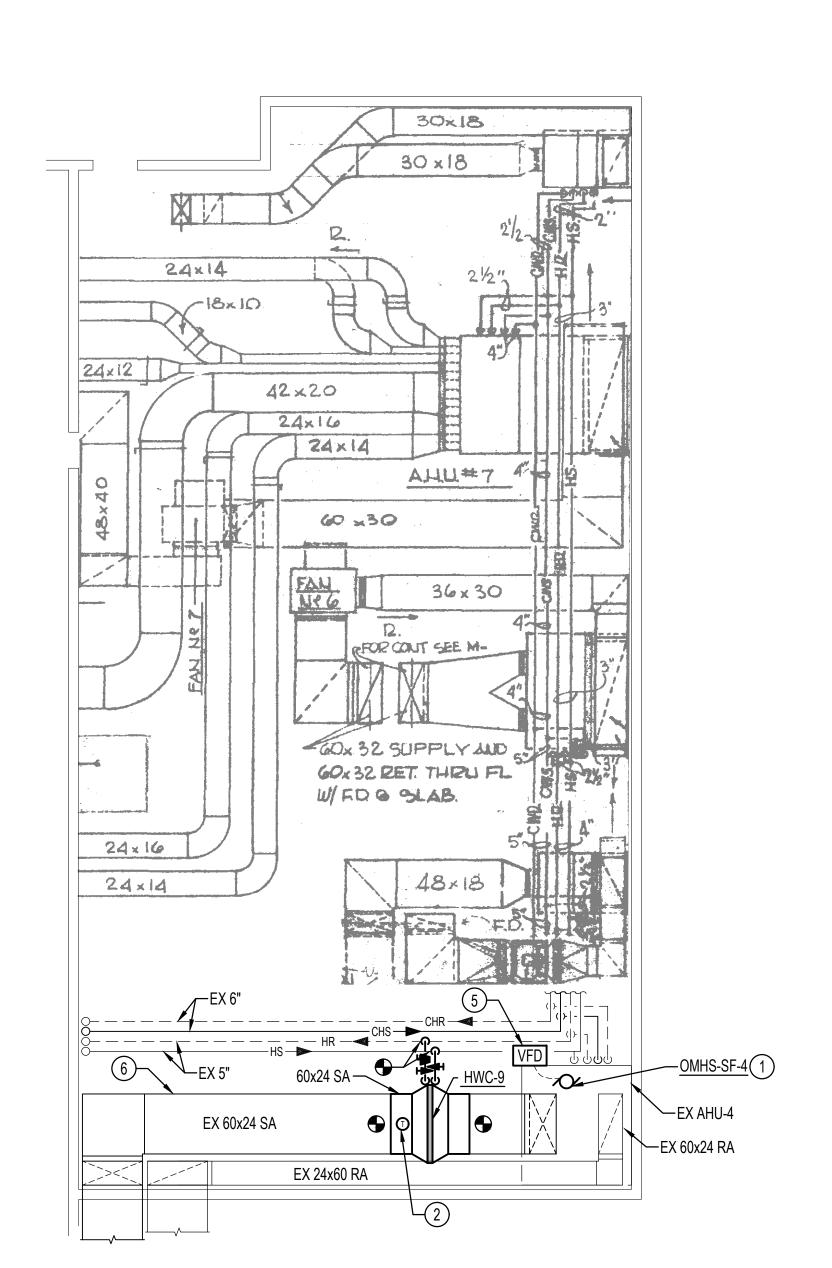



- 1) PROVIDE NEW INVERTER DUTY FAN MOTOR FOR OMHS-SF-4. REFER TO SCHEDULE ON DRAWING M801 FOR SIZE.
- 2 PROVIDE DUCT-MOUNTED TEMPERATURE SENSOR. REFER TO AUTOMATIC CONTROLS DRAWINGS FOR ADDITIONAL INFORMATION.
- 3 REMOVE EXISTING TEMPERATURE SENSOR FOR THE AIR HANDLING UNIT. REMOVE ALL CONTROL WIRING OR PNEUMATIC TUBING BACK TO MAIN ATC PANEL. PROVIDE COMBINATION DDC SPACE TEMPERATURE, HUMIDITY & CO2 SENSOR FOR EACH AIR HANDLING UNIT IN SAME LOCATION AS EXISTING TEMPERATURE SENSOR.
- 4 PROVIDE CEILING-MOUNTED SPACE OCCUPANCY SENSORS FOR AHU-3. COORDINATE SPACE OCCUPANCY SENSOR LOCATIONS WITH EXISTING CEILING DEVICES. CONTRACTOR SHALL ADJUST SENSOR QUANTITY AND LOCATIONS BASED ON SENSOR RANGE.
- 5 VFD SHALL BE MOUNTED ON UNITSTRUT FRAMING. UNITSTRUT FRAMING SHALL BE SUPPORTED BY EXISTING STRUCTURE.
- 6 BALANCE THE AIRFLOW FOR ALL AIR INLETS AND OUTLETS TO THE DESIGN AIRFLOW RATES SHOWN ON THE ORIGINAL BUILDING DRAWINGS. REFER TO DRAWING 4/M202 FOR THE DESIGN AIRFLOW RATES.

DRAWING NOTES: (APPLICABLE TO THIS DRAWING ONLY)

- 1. EXISTING SHOWN WITH LIGHT WEIGHT LINE, —————
- 2. DEMOLITION SHOWN WITH HEAVY WEIGHT, DASHED LINE, -----

NEW WORK SHOWN WITH HEAVY WEIGHT LINE, ———

- 4. INFORMATION SHOWN ON THIS DRAWING PERTAINING TO EXISTING CONDITIONS HAS BEEN OBTAINED FROM AVAILABLE BUILDING DRAWINGS OR GENERAL FIELD OBSERVATIONS AND MAY NOT INDICATE ACTUAL EXISTING CONDITIONS IN DETAIL OR DIMENSION. EXISTING CONDITIONS ARE SHOWN IN AN APPROXIMATE WAY ONLY. THE CONTRACTOR SHALL BE RESPONSIBLE FOR DETERMINING THE ACTUAL EXISTING CONDITIONS PRIOR TO FABRICATION OR PERFORMANCE OF ANY WORK. SHOULD CONDITIONS BE DISCOVERED THAT PREVENT EXECUTION OF THE WORK AS INDICATED, OR THERE IS A QUESTION REGARDING SCOPE OF WORK OR LIMITS OF DISTURBANCE, THE CONTRACTOR SHALL IMMEDIATELY NOTIFY THE COR IN WRITING AND AWAIT WRITTEN DIRECTION BEFORE
 - PROCEEDING WITH THE WORK.

 ALL ITEMS THAT REQUIRE ACCESS FOR OPERATING, CLEANING, SERVICING, MAINTENANCE, AND CALIBRATION, SHALL BE EASILY AND SAFELY ACCESSIBLE. EXAMPLES OF THESE ITEMS INCLUDE, BUT ARE NOT LIMITED TO: ALL TYPES OF VALVES, FILTERS, STRAINERS, TRANSMITTERS, AND CONTROL DEVICES. PRIOR TO COMMENCING INSTALLATION WORK, REFER CONFLICTS BETWEEN THIS REQUIREMENT AND CONTRACT DRAWINGS TO THE COR FOR RESOLUTION.
- 6. FOR WORK ABOVE SUSPENDED CEILINGS: CAREFULLY REMOVE CEILING TILES AND CEILING GRID AS REQUIRED. TEMPORARILY RELOCATE AND PROTECT EXISTING LIGHTING FIXTURES AND OTHER DEVICES INSTALLED IN THE CEILING, SUCH AS PUBLIC ADDRE SPEAKERS, WIRELESS ACCESS POINTS, ETC. RELOCATE EXISTING ELECTRICAL POWER WIRING, CONDUITS, AND SPRINKLER PIPIN AS REQUIRED TO ACCOMMODATE THE WORK. UPON COMPLETION OF WORK ABOVE CEILING, PROVIDE A NEW CEILING GRID (EQUATO CHICAGO METALLIC 200 SERIES, USG DONN BRAND DX, OR ARMSTRONG PRELUDE XL SERIES) AND NEW CEILING TILES (EQUAL ARMSTRONG SCHOOL ZONE FINE FISSURED, CERTAINTEED FINE FISSURED HIGH NRC, OR UNITED STATES GYPSUM RADAR CLIMAT PLUS HIGH NRC LAY-IN PANELS WITH HIGH MOISTURE AND HIGH HEAT RESISTANCE).





MECHANICAL ELECTRICAL & PLUMBING ENGINEERS

MEP ENGINEERING
HENRY ADAMS,LLC
600 BALTIMORE AVENUE
SUITE 400
BALTIMORE, MD 21204

PROJECT

(410) 296-6500

HOWARD COUNTY PUBLIC SCHOOLS

CAFETERIA HVAC UNIT CONVERSIONS

CONSTRUCTION DOCUMENTS 05/25/2023


SEAL

PROFESSIONAL CERTIFICATION: I HEREBY CERTIFY THAT THESE DOCUMENTS WERE PREPARED OR APPROVED BY ME, AND THAT I AM A DULY LICENSED PROFESSIONAL ENGINEER UNDER THE I AWS OF THE STATE OF MARYI AND.

LICENSE NO: 37247

NO. DESCRIPTION DATE

NO. KEY PLAN

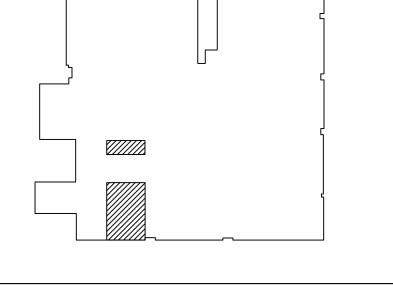

OAKLAND MILLS HS - MECHANICAL WORK


PROJECT NUMBER PO-10028674

DATE 05/25/2023

DRAWN BY NCV

CHECKED BY BMB


M109

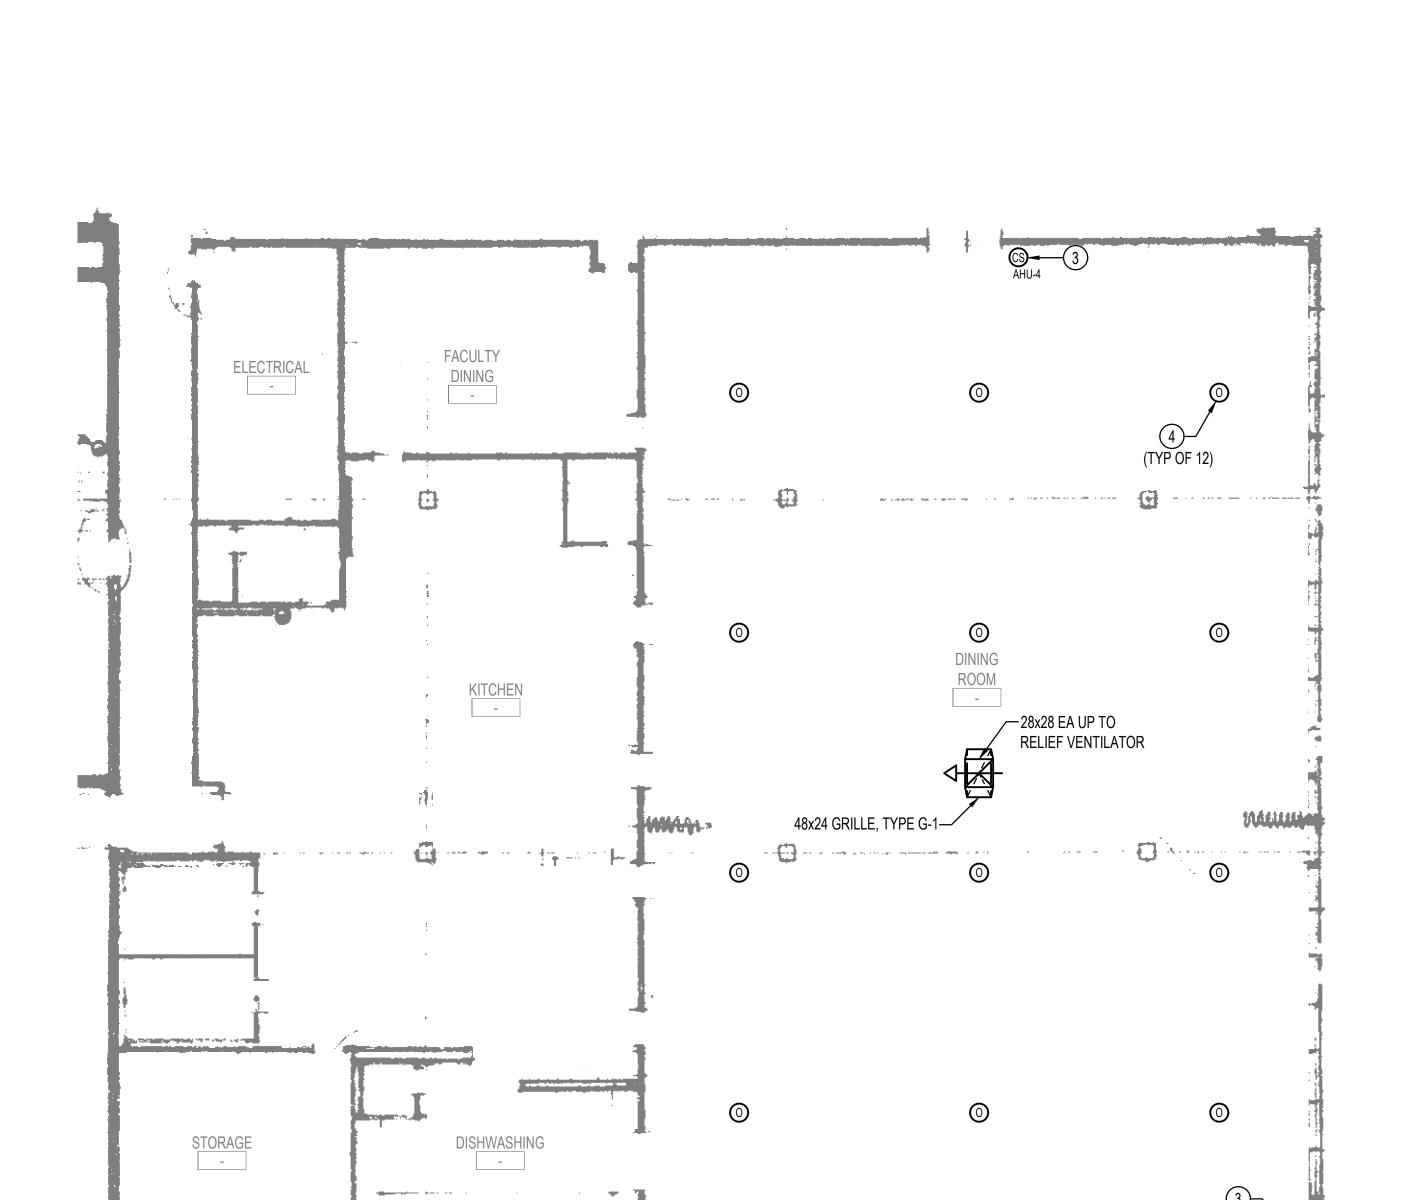


OAKLAND MILLS HS - PARTIAL FIRST FLOOR PLAN - MECHANICAL - NEW WORK

M109 1/8" = 1'-0"

EX ACU-6 ON ROOF ABOVE-

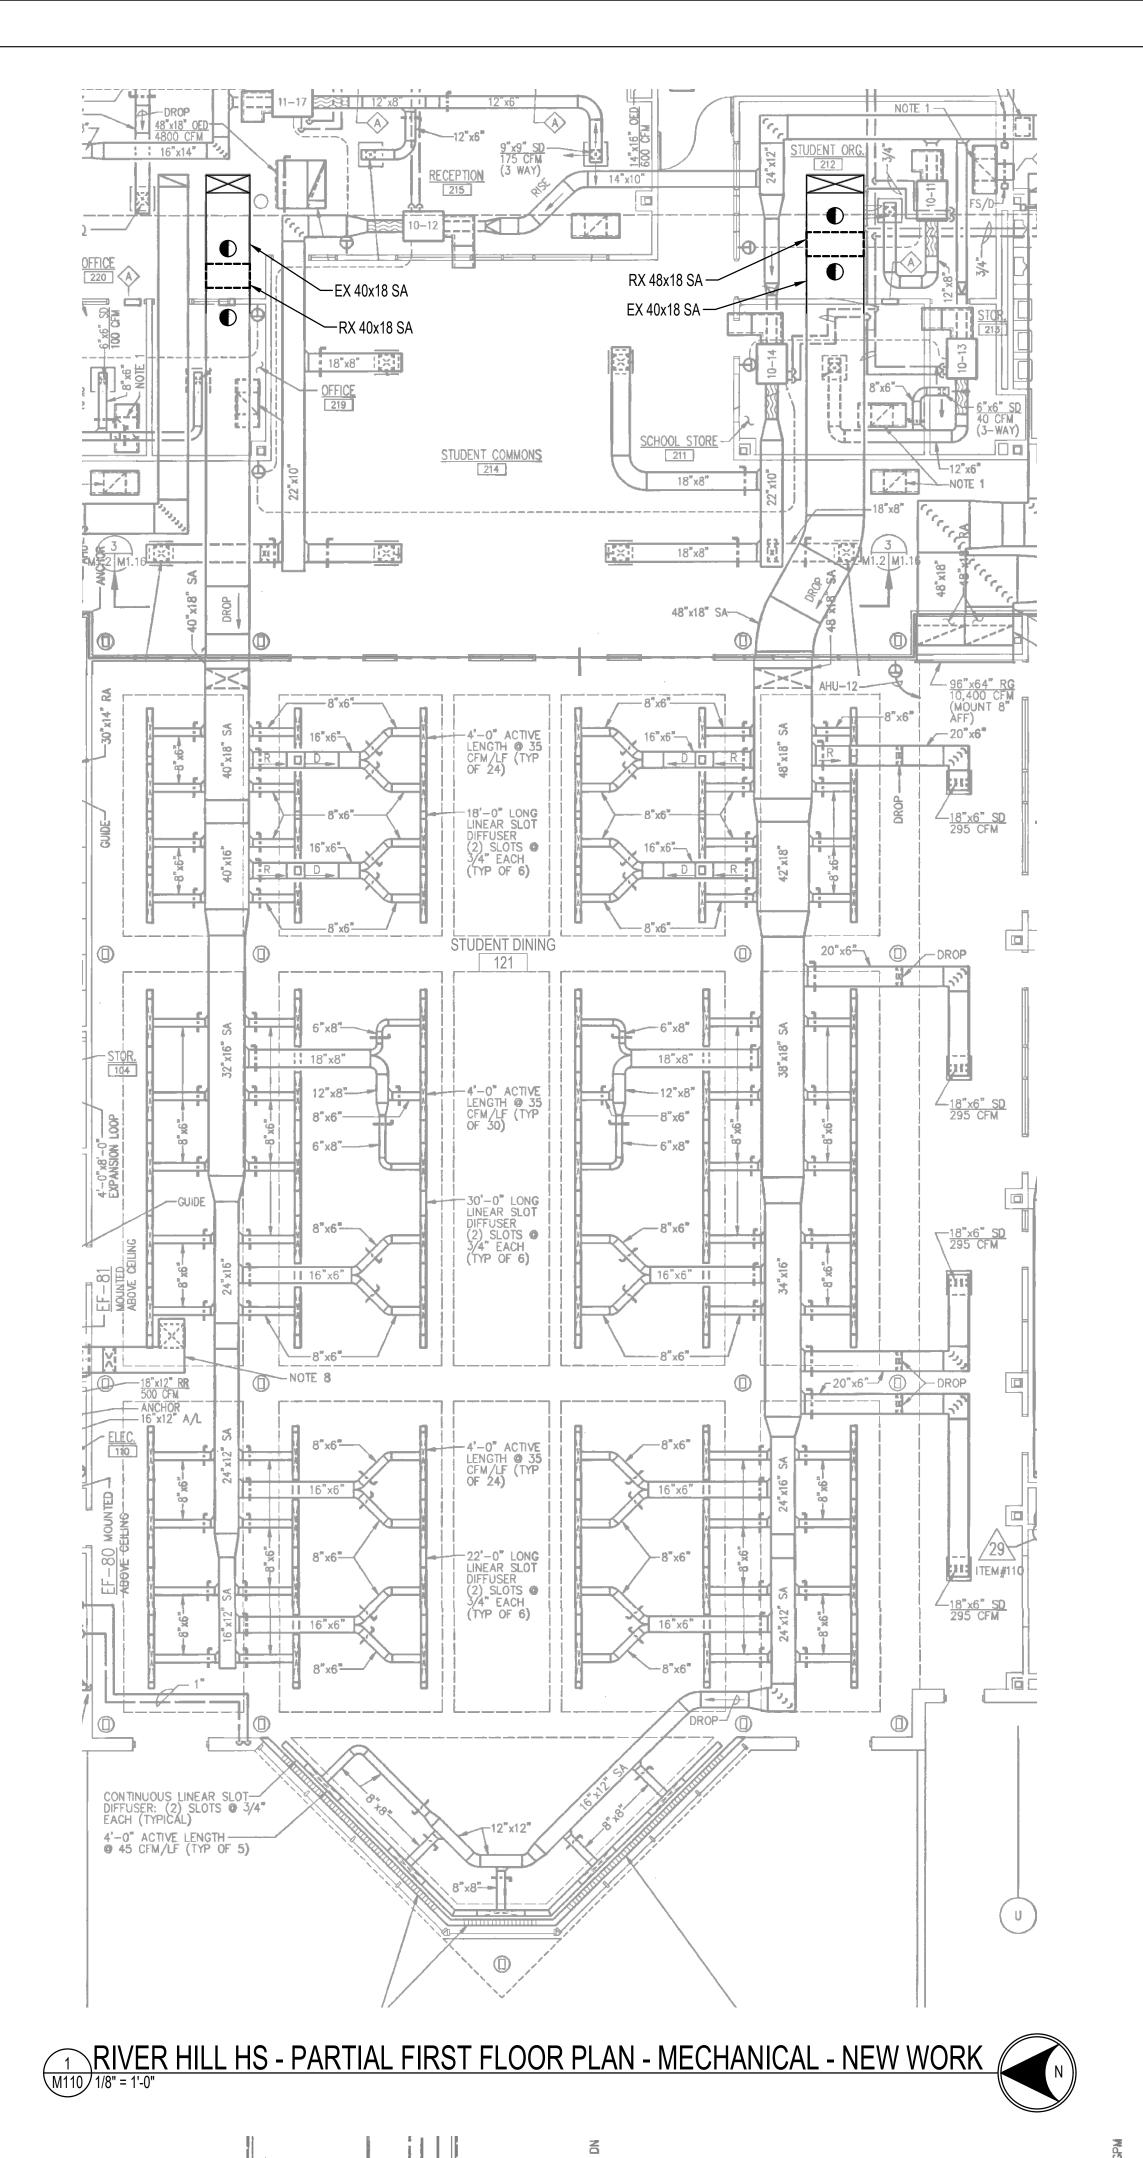

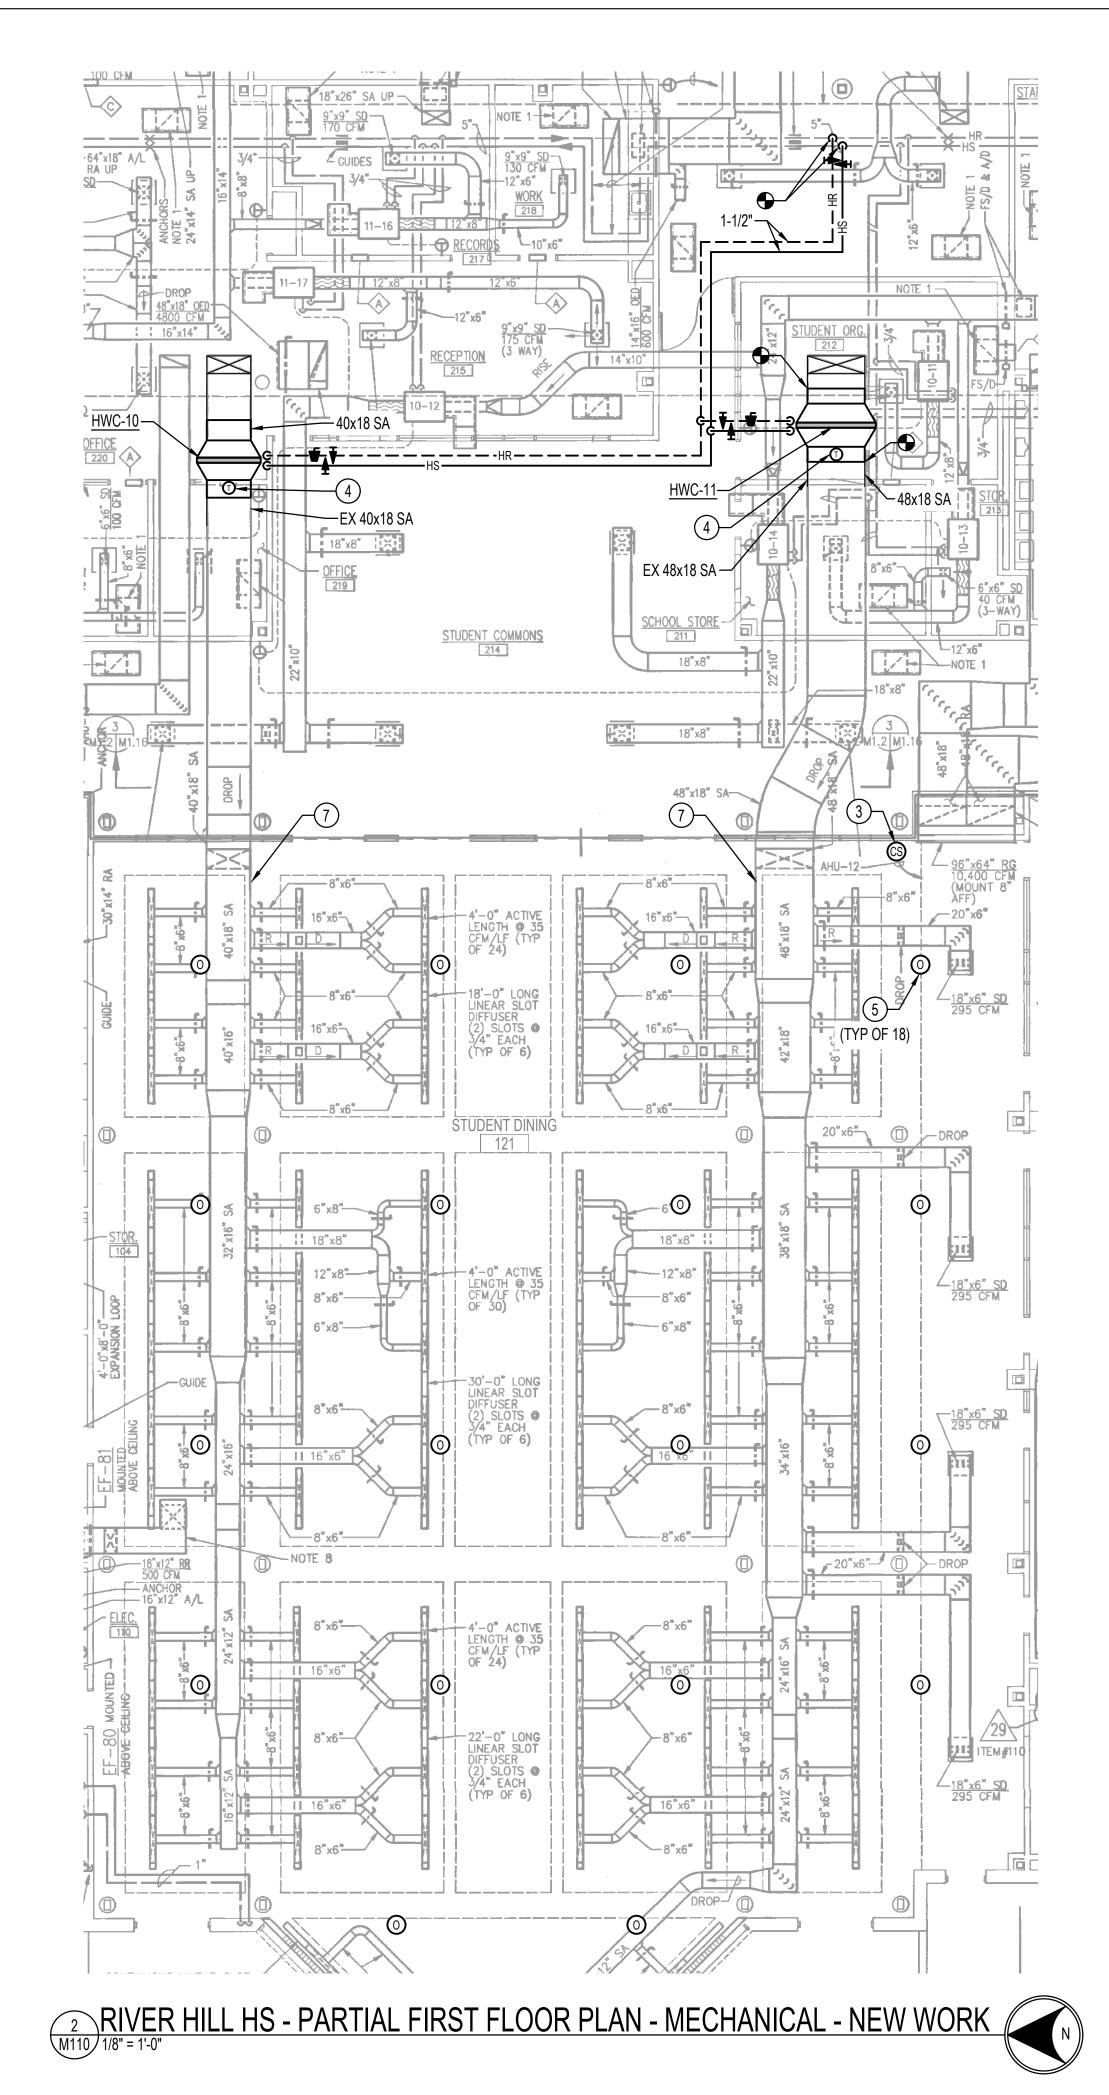

<u>DRAWING NOTES</u>: (APPLICABLE TO THIS DRAWING ONLY)

- EXISTING SHOWN WITH LIGHT WEIGHT LINE, ————
- DEMOLITION SHOWN WITH HEAVY WEIGHT, DASHED LINE, -----
- NEW WORK SHOWN WITH HEAVY WEIGHT LINE, ————

- PLUS HIGH NRC LAY-IN PANELS WITH HIGH MOISTURE AND HIGH HEAT RESISTANCE).

SPECIAL NOTES: (APPLICABLE TO THIS DRAWING ONLY)

- (1) PROVIDE NEW INVERTER DUTY FAN MOTOR FOR RHHS-RF-12. REFER TO SCHEDULE ON DRAWING M801 FOR SIZE.

- EXISTING CEILING DEVICES. CONTRACTOR SHALL ADJUST SENSOR QUANTITY AND LOCATIONS BASED ON SENSOR RANGE.
- (6) VFD SHALL BE WALL MOUNTED.
- (7) BALANCE THE AIRFLOW FOR ALL AIR INLETS AND OUTLETS TO THE DESIGN AIRFLOW RATES SHOWN ON THE ORIGINAL BUILDING DRAWINGS. REFER TO DRAWING 1/M110 FOR THE DESIGN AIRFLOW RATES.





MECHANICAL ELECTRICAL & PLUMBING ENGINEERS

MEP ENGINEERING HENRY ADAMS,LLC 600 BALTIMORE AVENUE SUITE 400 BALTIMORE, MD 21204

(410) 296-6500

PROJECT

HOWARD COUNTY PUBLIC SCHOOLS

CAFETERIA HVAC UNIT CONVERSIONS


CONSTRUCTION DOCUMENTS

PROFESSIONAL CERTIFICATION: I HEREBY CERTIFY THAT THESE DOCUMENTS WERE PREPARED OR APPROVED BY ME, AND THAT I AM A DULY LICENSED PROFESSIONAL

LICENSE NO: 37247

EXPIRATION DATE: 01/09/2024 DESCRIPTION

KEY PLAN

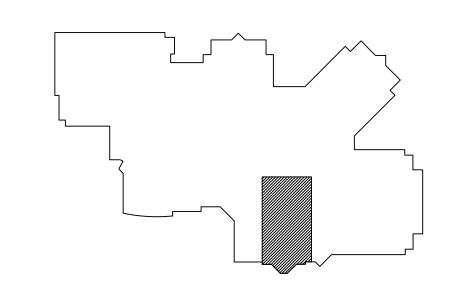

RIVER HILL HS - MECHANICAL WORK

PROJECT NUMBER PO-10028674 DATE 05/25/2023 DRAWN BY CHECKED BY

M110

EVAPORATIVE — CONDENSER—3 4" SAN DN ---WATER TREATMENT -(FOR EVAPORATIVE CONDENSER-3) EX AHU-12



401 of 424

RIVER HILL HS - PENTHOUSE NO. 2 PART PLAN - MECHANICAL - NEW WORK



EX AHU-12

RX MOTOR RF-12—

EVAPORATIVE — CONDENSER—3

4" SAN DN

WATER TREATMENT -(FOR EVAPORATIVE CONDENSER-3)

-) REMOVE EXISTING TEMPERATURE SENSOR FOR THE AIR HANDLING UNIT. REMOVE ALL CONTROL WIRING OR PNEUMATIC TUBING BACK TO MAIN ATC PANEL. PROVIDE COMBINATION DDC SPACE TEMPERATURE, HUMIDITY & CO2 SENSOR FOR EACH AIR HANDLING UNIT IN SAME LOCATION AS EXISTING TEMPERATURE SENSOR.
- 2 $\big)$ PROVIDE DUCT-MOUNTED TEMPERATURE SENSOR. REFER TO AUTOMATIC CONTROLS DRAWINGS FOR ADDITIONAL INFORMATION
- EXISTING CEILING DEVICES. CONTRACTOR SHALL ADJUST SENSOR QUANTITY AND LOCATIONS BASED ON SENSOR RANGE.
- 4) BALANCE THE AIRFLOW FOR ALL AIR INLETS AND OUTLETS TO THE DESIGN AIRFLOW RATES SHOWN ON THE ORIGINAL BUILDING DRAWINGS. REFER TO DRAWING 1/M203 FOR THE DESIGN AIRFLOW RATES.

DRAWING NOTES: (APPLICABLE TO THIS DRAWING ONLY)

- EXISTING SHOWN WITH LIGHT WEIGHT LINE, ————
- DEMOLITION SHOWN WITH HEAVY WEIGHT, DASHED LINE, -----

NEW WORK SHOWN WITH HEAVY WEIGHT LINE, ————

- THAT PREVENT EXECUTION OF THE WORK AS INDICATED, OR THERE IS A QUESTION REGARDING SCOPE OF WORK OR LIMITS OF PROCEEDING WITH THE WORK.
- TRANSMITTERS, AND CONTROL DEVICES. PRIOR TO COMMENCING INSTALLATION WORK, REFER CONFLICTS BETWEEN THIS REQUIREMENT AND CONTRACT DRAWINGS TO THE COR FOR RESOLUTION
- PLUS HIGH NRC LAY-IN PANELS WITH HIGH MOISTURE AND HIGH HEAT RESISTANCE).





MECHANICAL ELECTRICAL & PLUMBING ENGINEERS

MEP ENGINEERING HENRY ADAMS,LLC 600 BALTIMORE AVENUE SUITE 400 BALTIMORE, MD 21204

PROJECT

(410) 296-6500

HOWARD COUNTY PUBLIC SCHOOLS


CAFETERIA HVAC UNIT CONVERSIONS

CONSTRUCTION DOCUMENTS

PROFESSIONAL CERTIFICATION: I HEREBY CERTIFY THAT THESE DOCUMENTS WERE PREPARED OR APPROVED BY ME, AND THAT I AM A DULY LICENSED PROFESSIONAL


LICENSE NO: 37247 EXPIRATION DATE: 01/09/2024


NO.	DESCRIPTION	DATE
-		
KEY PLAN		

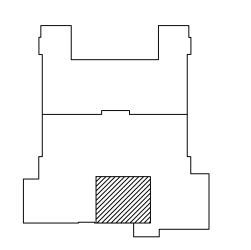


VETERANS ES - MECHANICAL WORK

PROJECT NUMBER	PO-10028674
DATE	05/25/2023
DRAWN BY	NCV
CHECKED BY	ВМВ

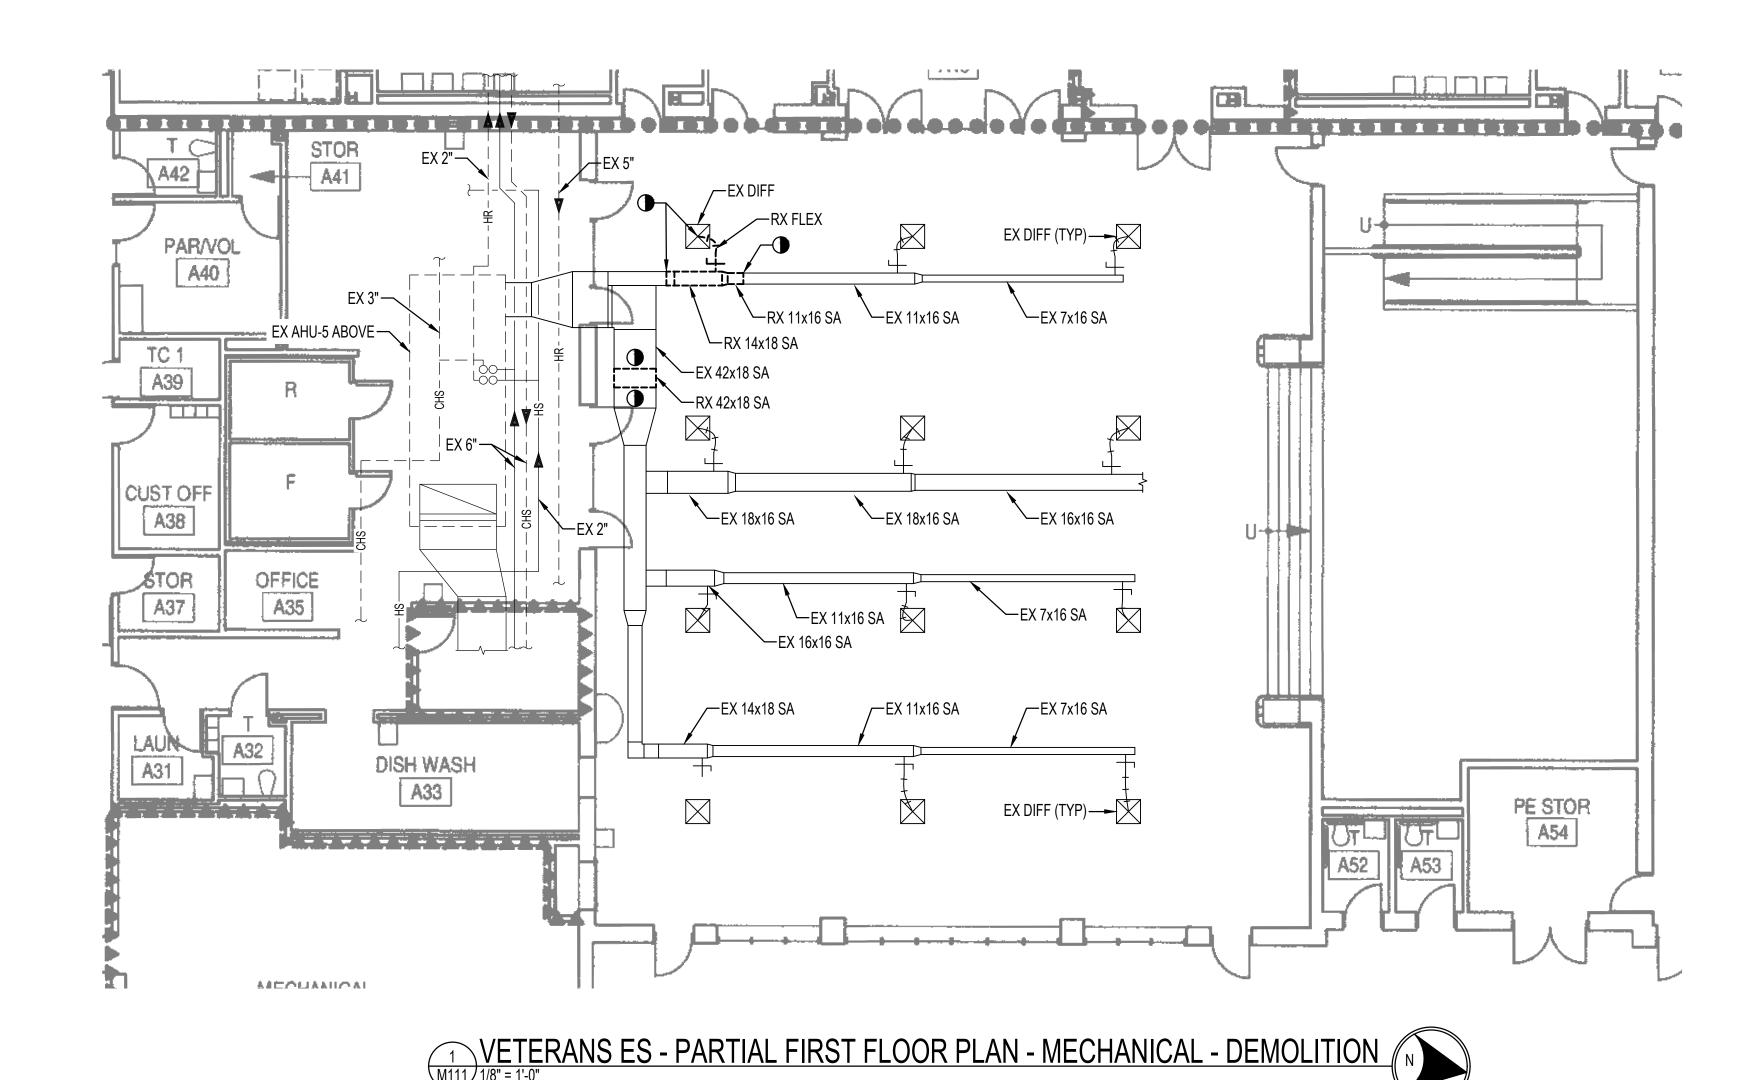


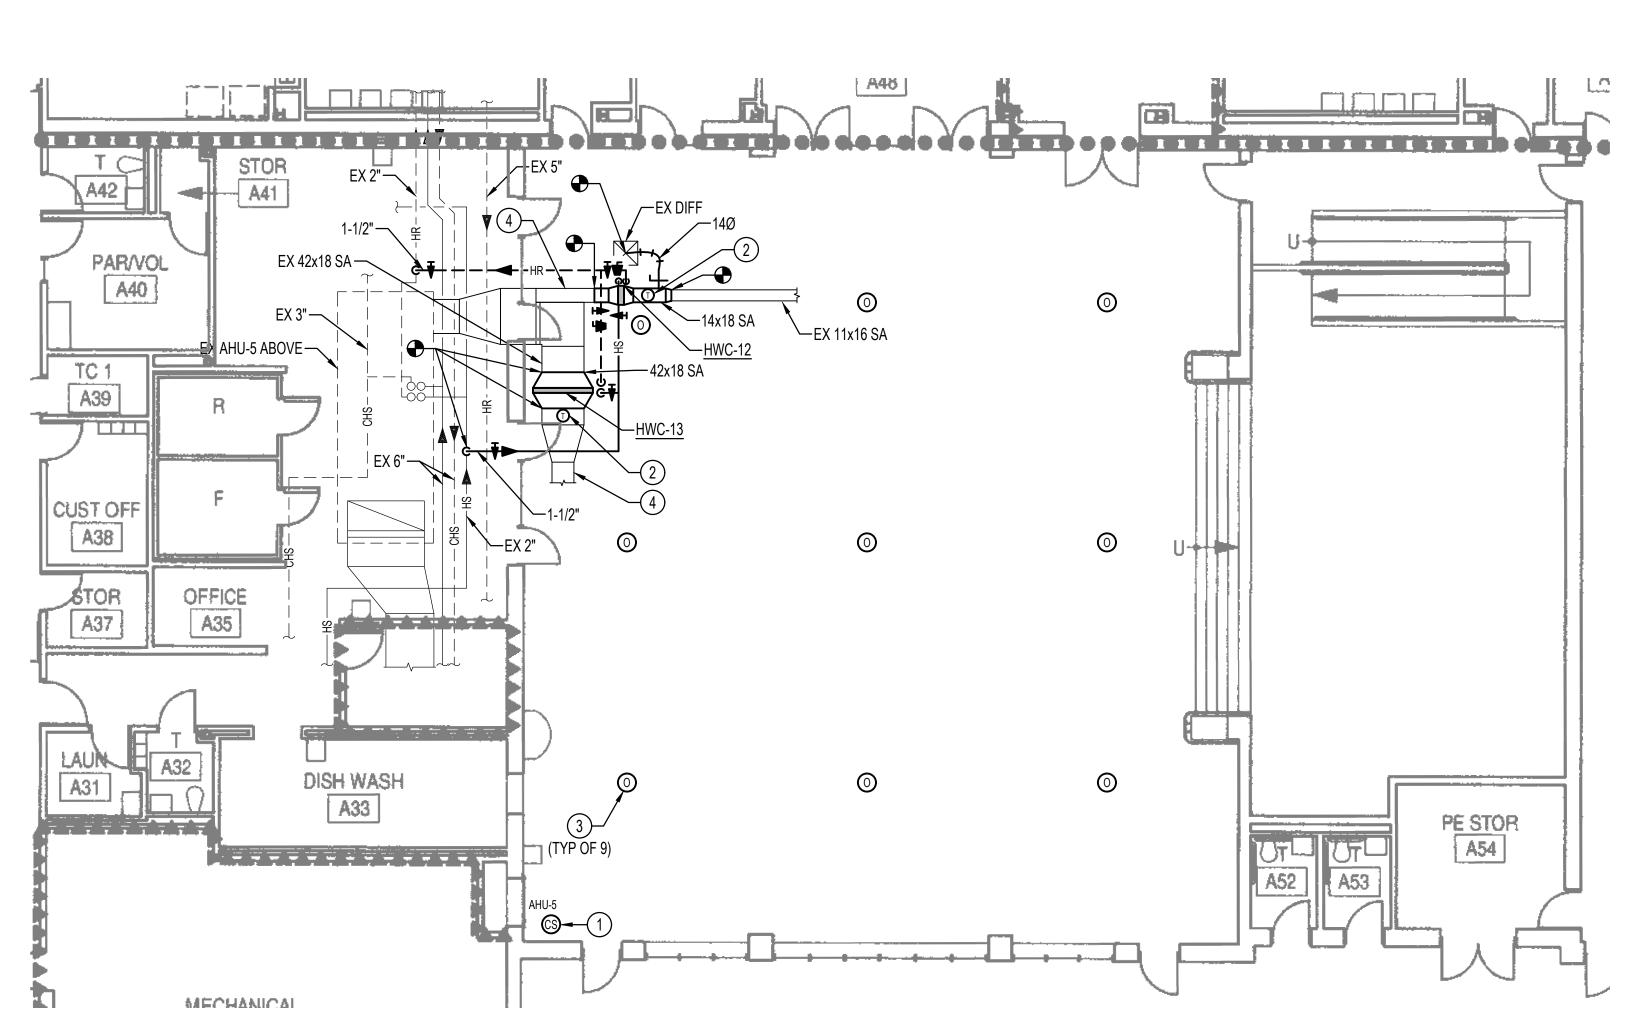




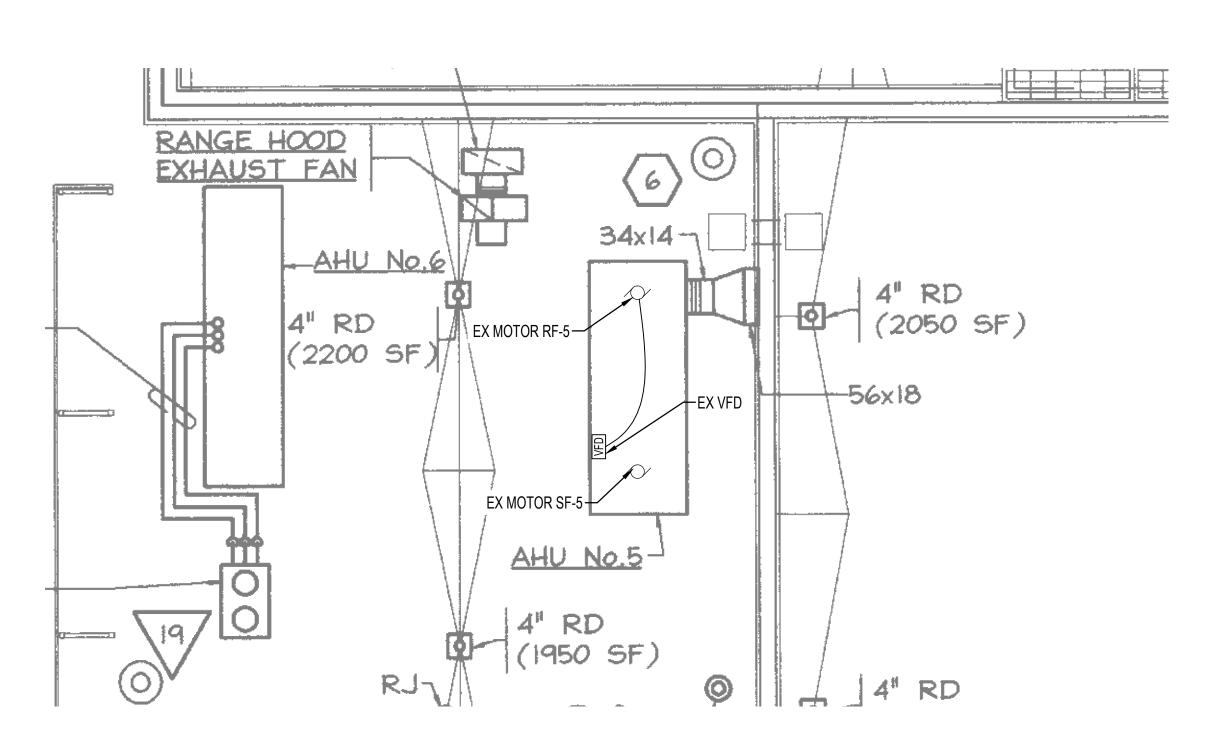


VETERANS ES - PARTIAL ROOF PLAN - MECHANICAL - DEMOLITION

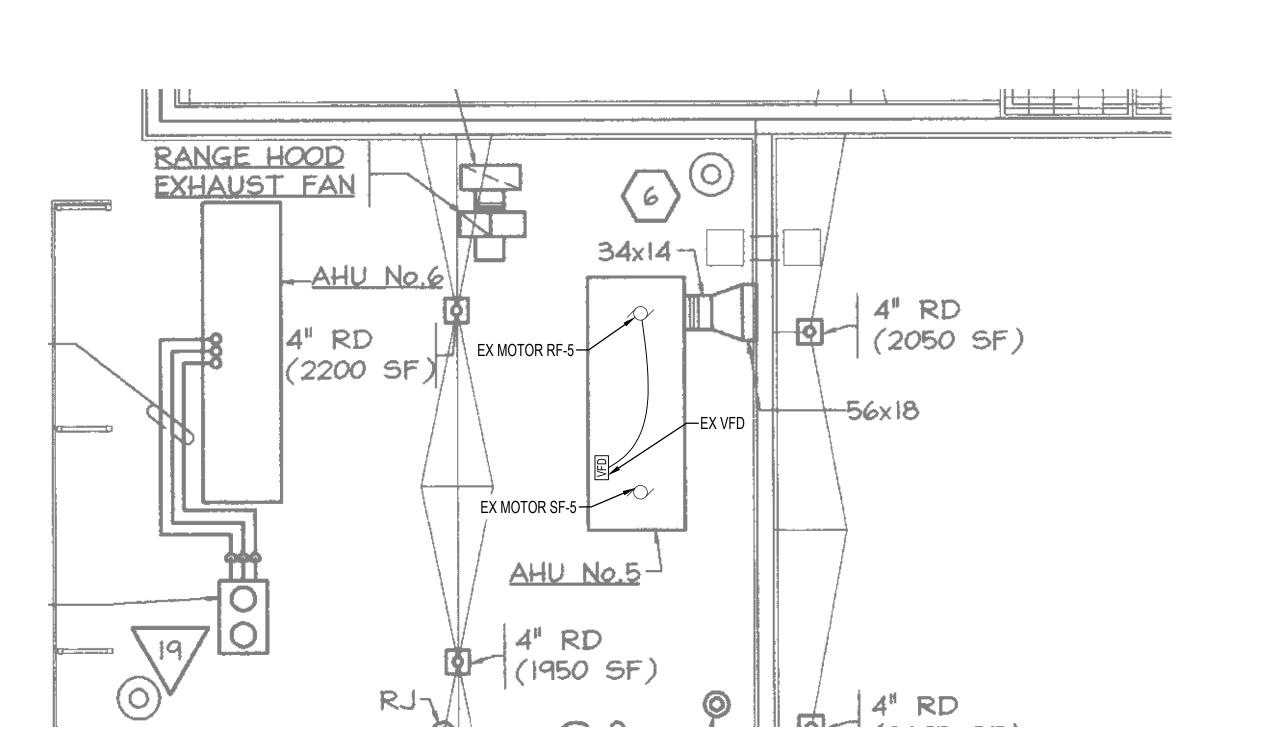


VETERANS ES - PARTIAL ROOF PLAN - MECHANICAL - NEW WORK

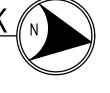

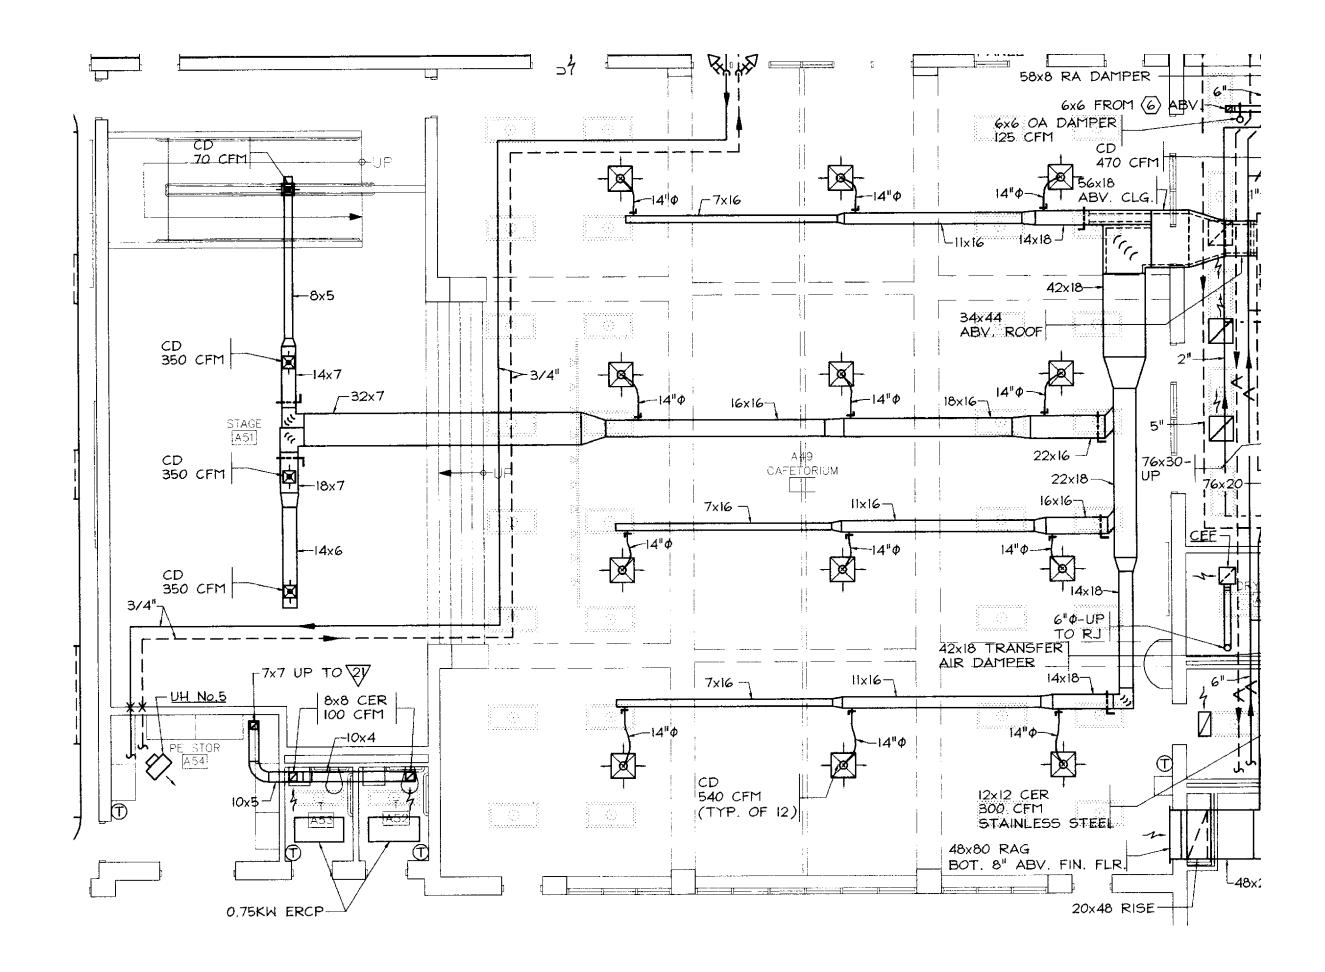


DAYTON OAKS ES - ORIGINAL DESIGN AIRFLOWS

1/8" = 1'-0"

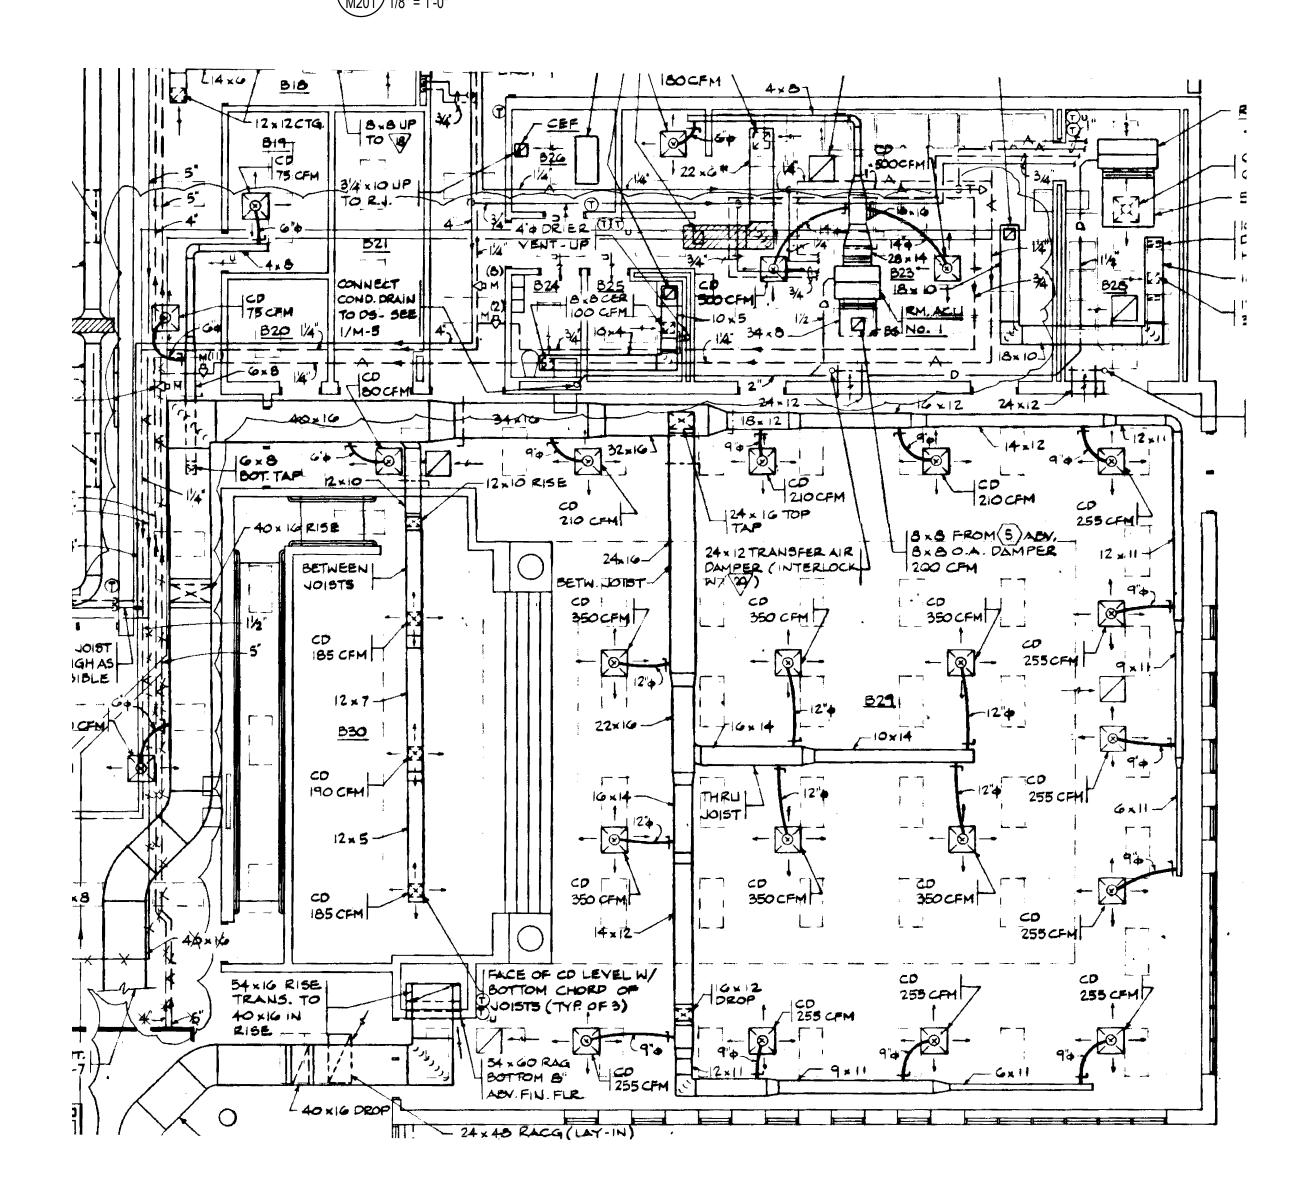


FULTON ES - ORIGINAL DESIGN AIRFLOWS

M201 1/8" = 1'-0"

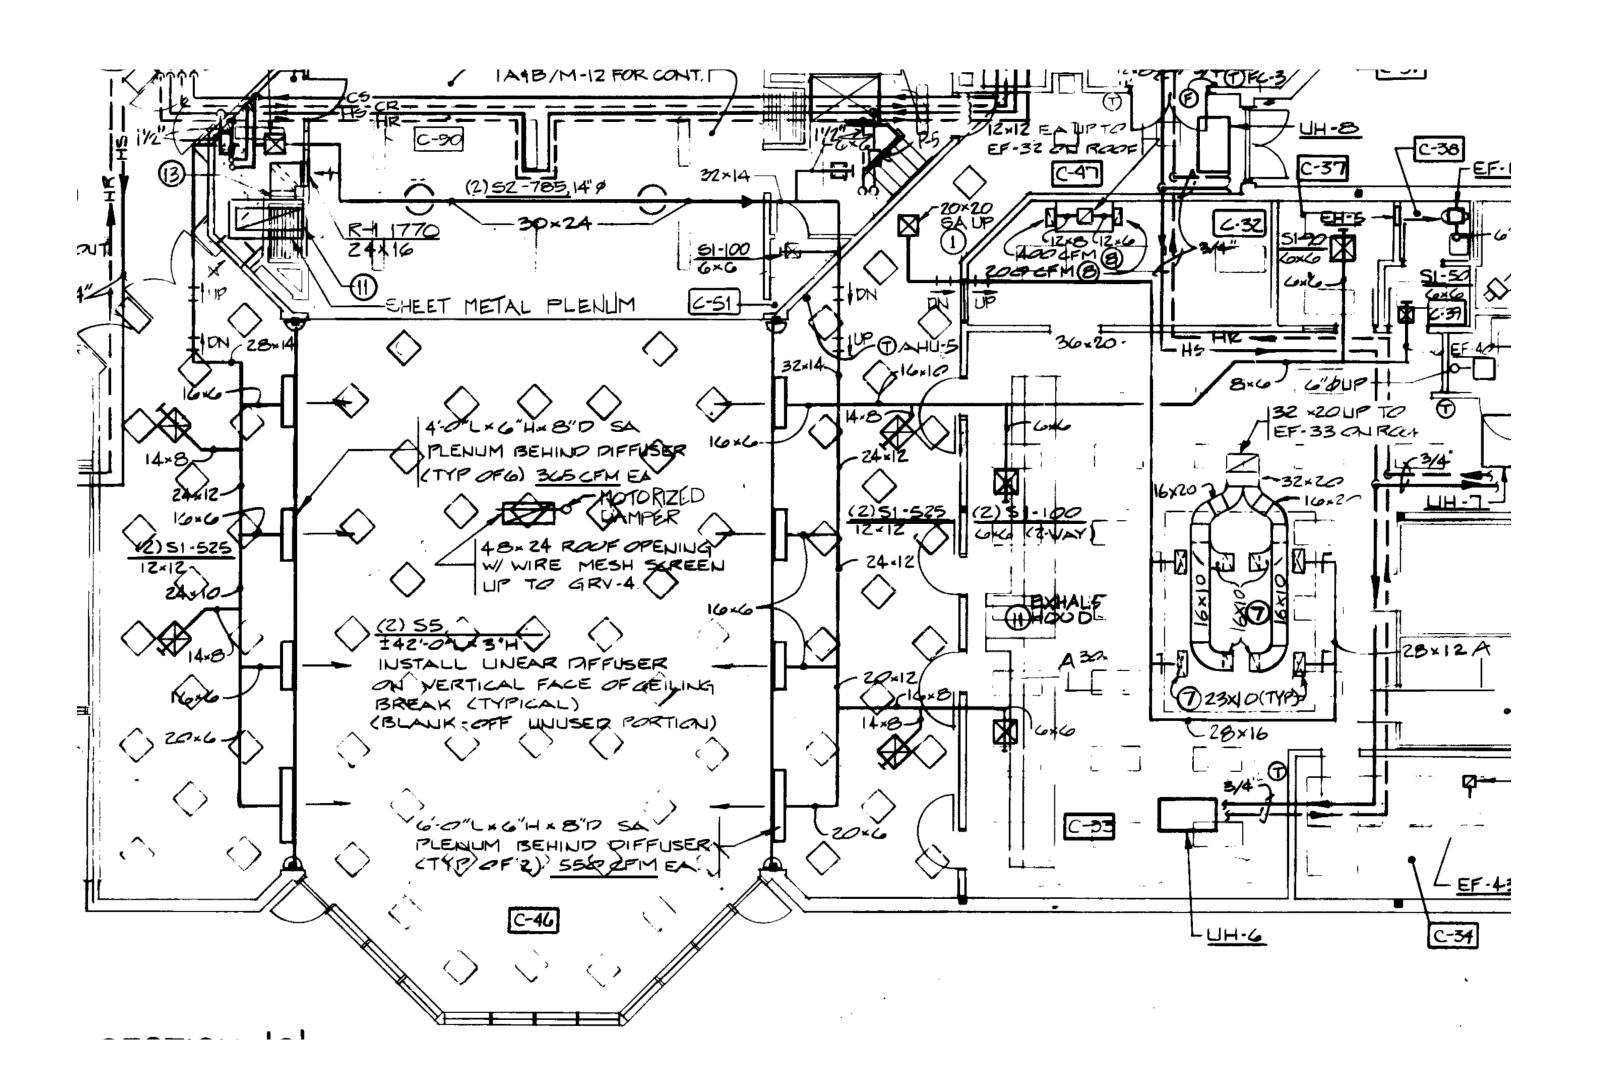

ELKRIDGE LANDING MS - ORIGINAL DESIGN AIRFLOWS

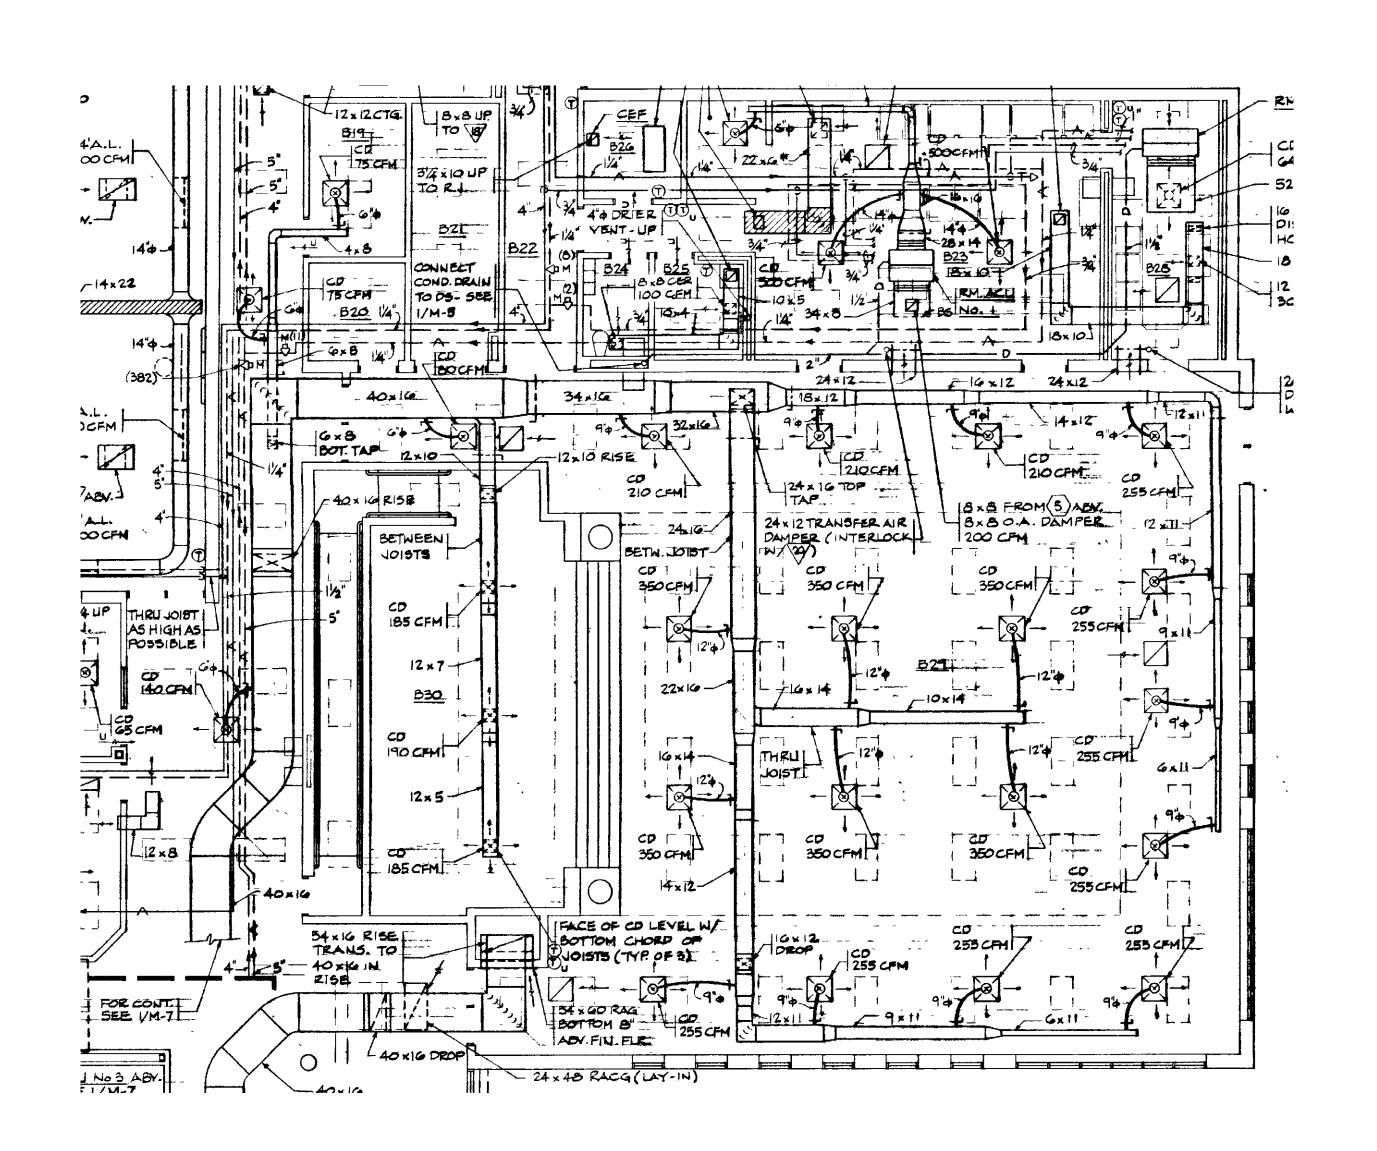

GORMAN CROSSING ES - ORIGINAL DESIGN AIRFLOWS



HENRY ADAMS Consulting Engineers

MECHANICAL ELECTRICAL & PLUMBING ENGINEERS

MEP ENGINEERING
HENRY ADAMS,LLC
600 BALTIMORE AVENUE
SUITE 400
BALTIMORE, MD 21204
(410) 296-6500

PROJECT

HOWARD COUNTY PUBLIC SCHOOLS

CAFETERIA HVAC UNIT CONVERSIONS

CONSTRUCTION DOCUMENTS

SEAL

PROFESSIONAL CERTIFICATION: I HEREBY CERTIFY THAT THESE DOCUMENTS WE PREPARED OR APPROVED BY ME, AND THAT I AM A DULY LICENSED PROFESSION ENGINEER UNDER THE LAWS OF THE STATE OF MARYLAND.

LICENSE NO: 37247

EXPIRATION DATE: 01/09/2024

NO.	DESCRIPTION	DATE

KEY PLAI

EXISTING AIRFLOW PLANS


PROJECT NUMBER PO-10028674


DATE 05/25/2023

DRAWN BY BMB


CHECKED BY SRH

1201

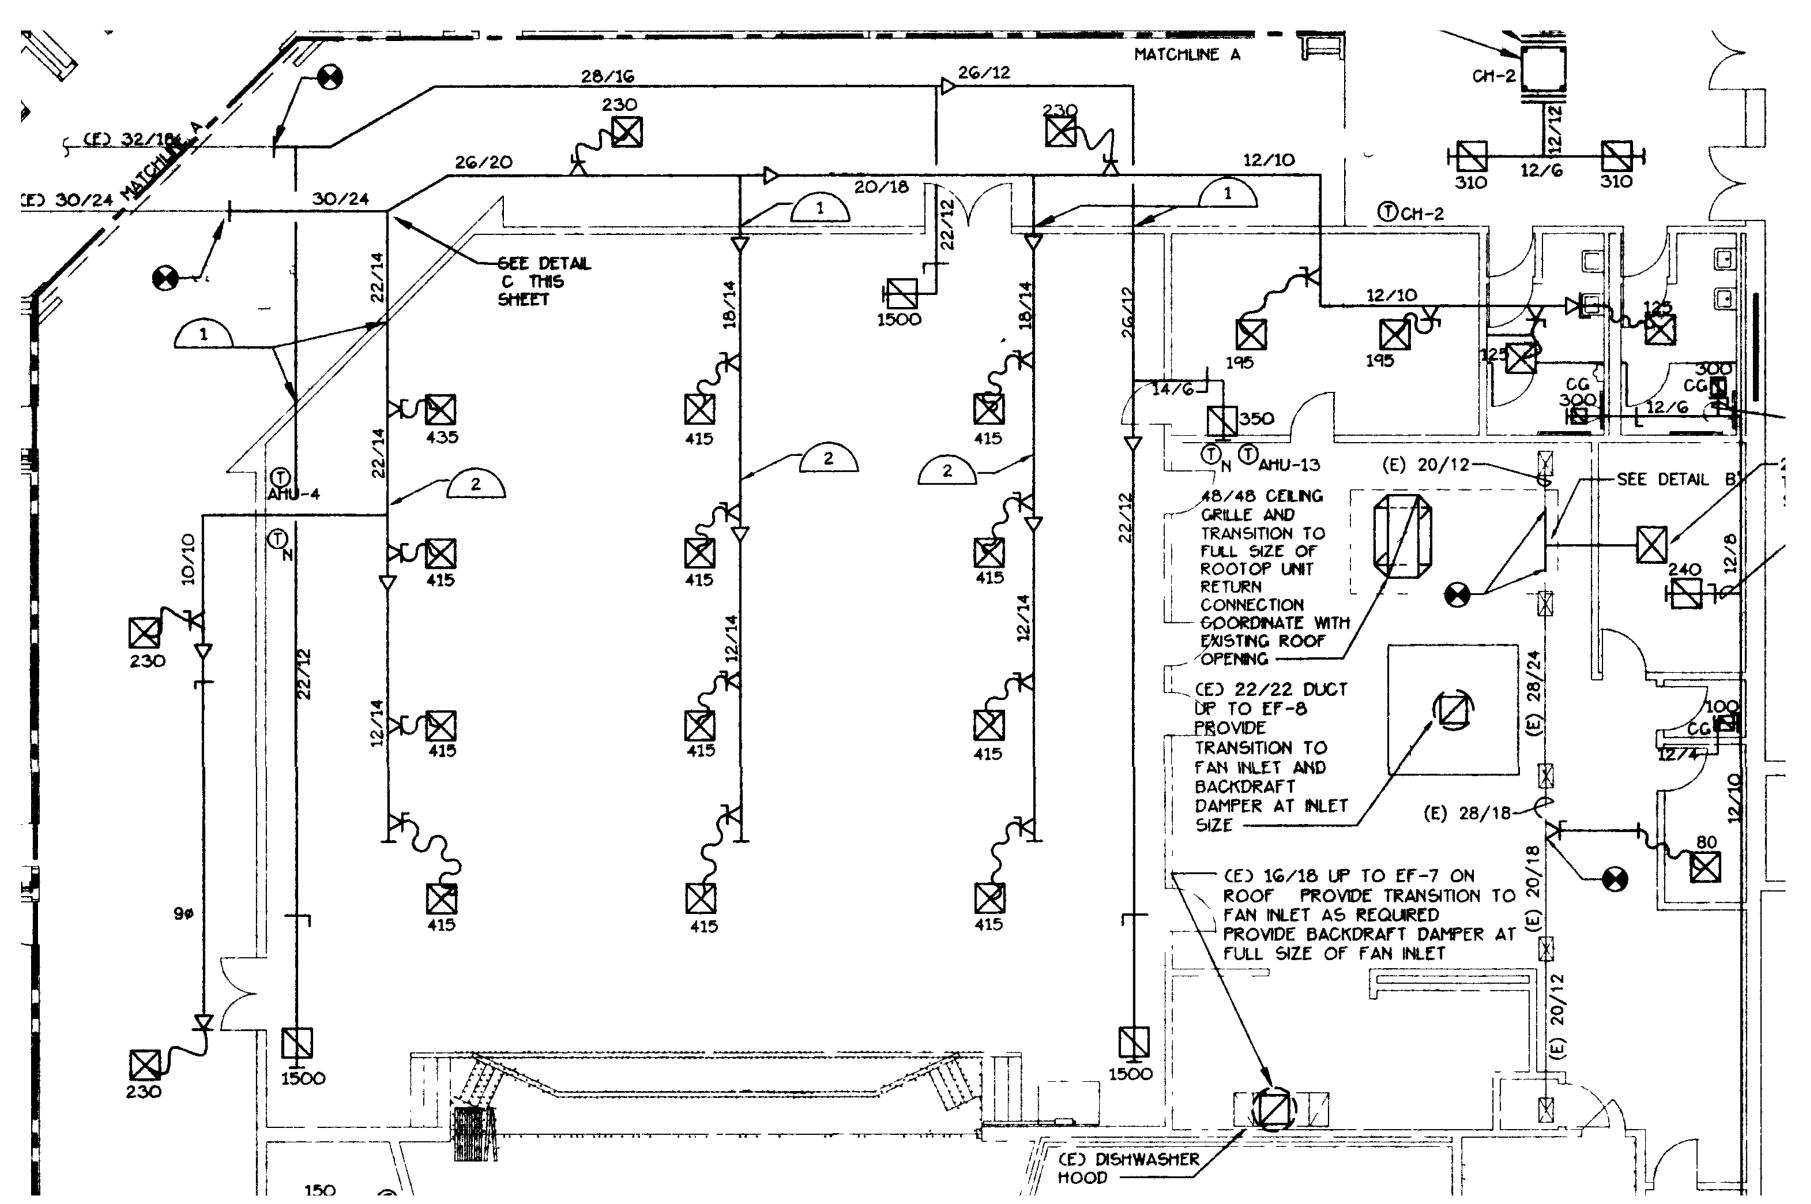

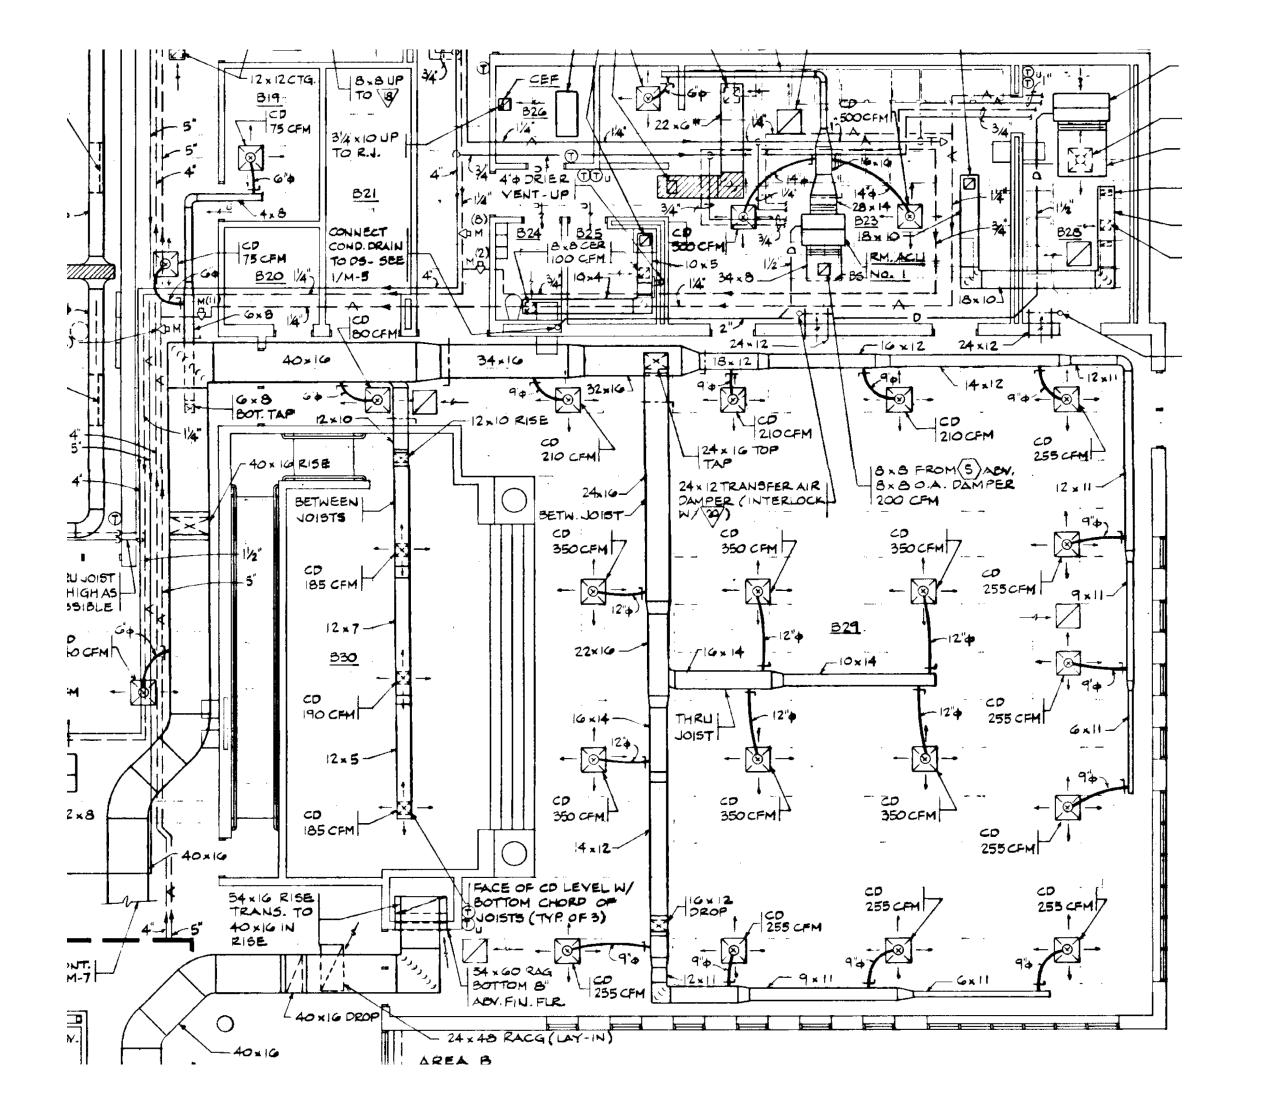

HOLLIFIELD STATION ES - ORIGINAL DESIGN AIRFLOWS

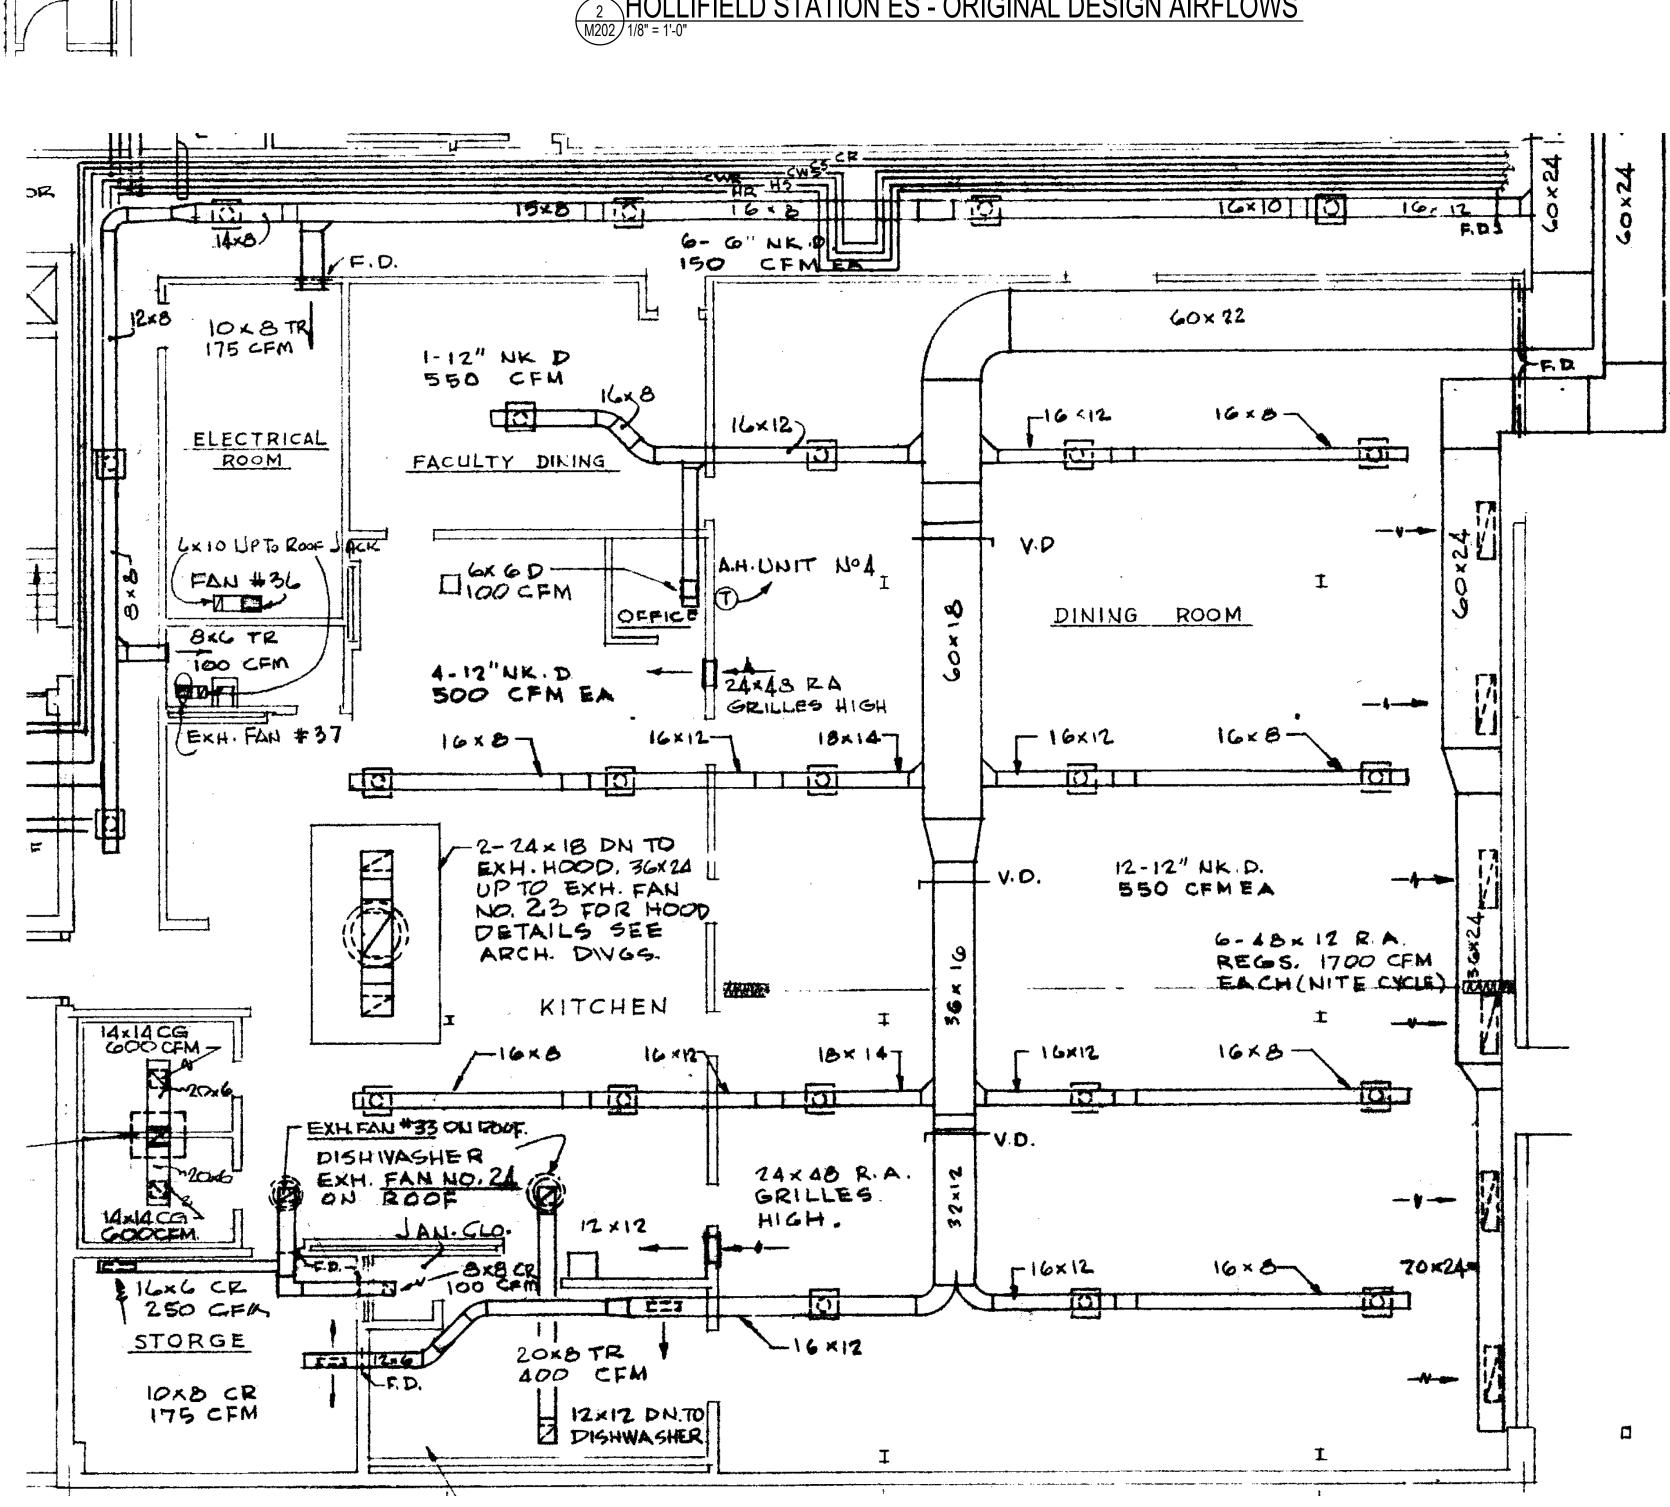


OAKLAND MILLS HS - ORIGINAL DESIGN AIRFLOWS

1/8" = 1'-0"



HARPERS CHOICE MS - ORIGINAL DESIGN AIRFLOWS

1/8" = 1'-0"

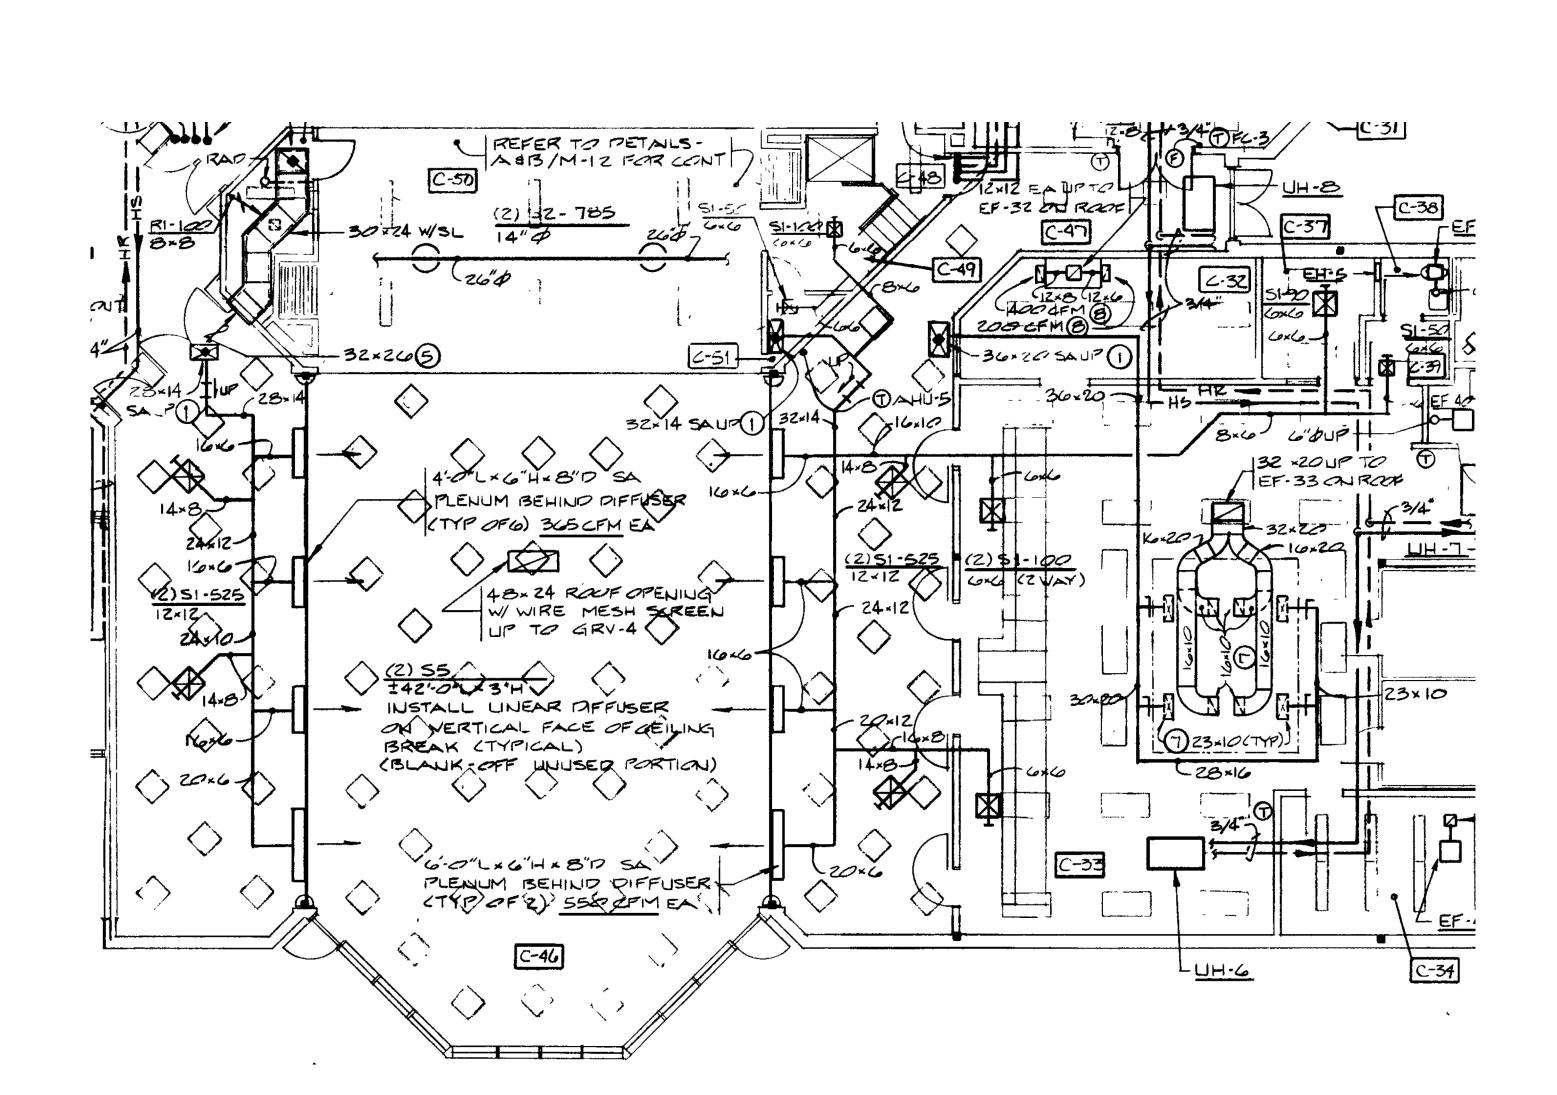

MAYFIELD WOODS MS - ORIGINAL DESIGN AIRFLOWS

M202 1/8" = 1'-0"



HENRY ADAMS Consulting Engineers

MECHANICAL ELECTRICAL & PLUMBING ENGINEERS

MEP ENGINEERING HENRY ADAMS,LLC 600 BALTIMORE AVENUE SUITE 400 BALTIMORE, MD 21204

PROJECT

(410) 296-6500

HOWARD COUNTY PUBLIC SCHOOLS

CAFETERIA HVAC UNIT CONVERSIONS

CONSTRUCTION DOCUMENTS


PREPARED OR APPROVED BY ME, AND THAT I AM A DULY LICENSED PROFESSIONAL

LICENSE NO: 37247 EXPIRATION DATE: 01/09/2024

DESCRIPTION **KEY PLAN**

EXISTING AIRFLOW PLANS

PROJECT NUMBER PO-10028674 DATE 05/25/2023 DRAWN BY CHECKED BY

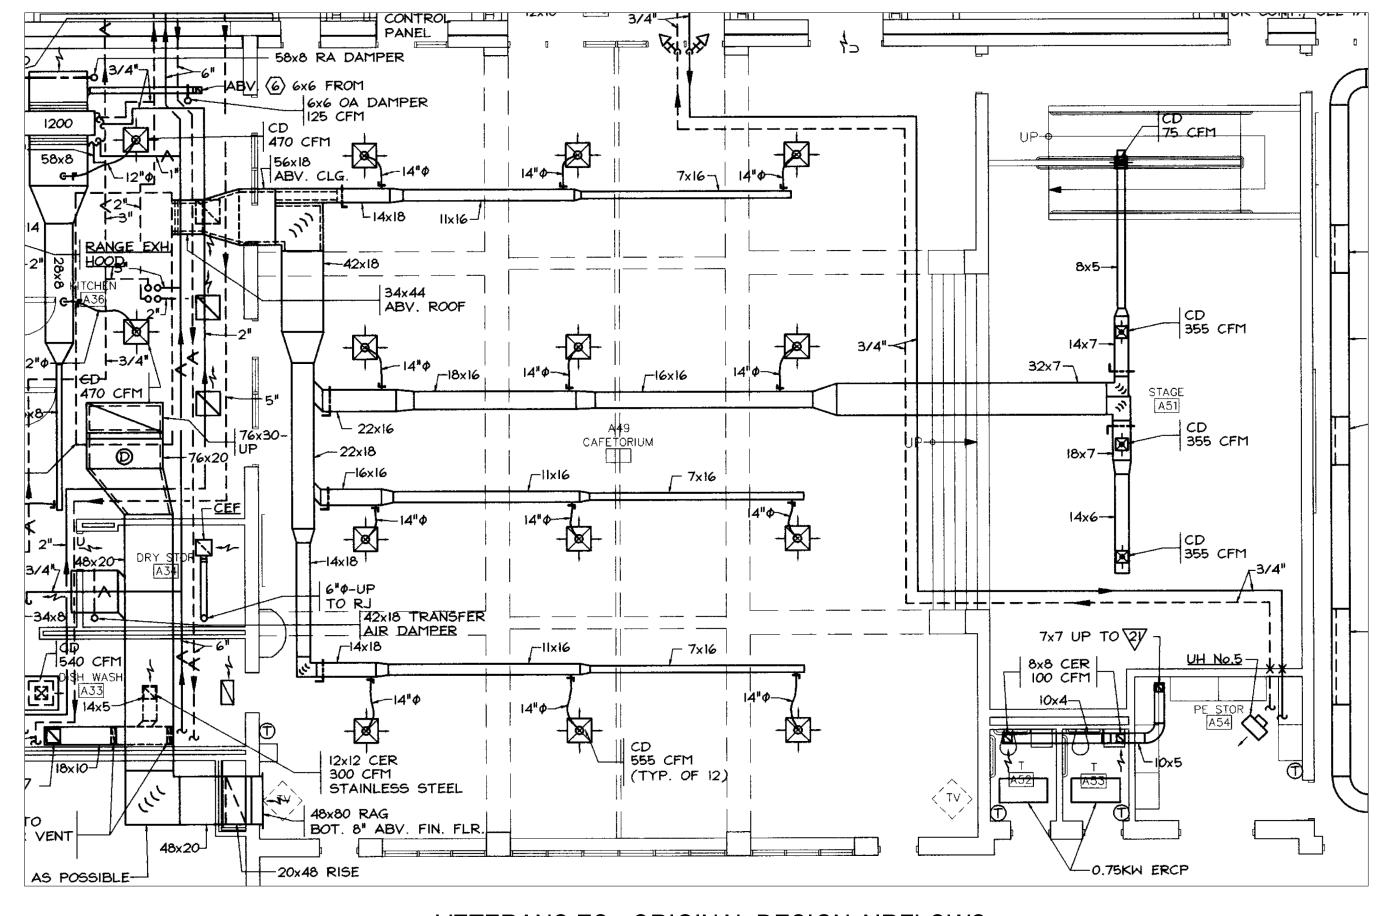

VETERANS ES - ORIGINAL DESIGN AIRFLOWS

M203 1/8" = 1'-0"



HENRY ADAMS

Consulting Engineers

MECHANICAL ELECTRICAL & PLUMBING ENGINEERS
MEP ENGINEERING
MENRY ADAMS.LLC

MEP ENGINEERING
HENRY ADAMS,LLC
600 BALTIMORE AVENUE
SUITE 400
BALTIMORE, MD 21204
(410) 296-6500

PROJECT

HOWARD COUNTY PUBLIC SCHOOLS

CAFETERIA HVAC UNIT CONVERSIONS

CONSTRUCTION DOCUMENTS 05/25/2023

SEA

PROFESSIONAL CERTIFICATION: I HEREBY CERTIFY THAT THESE DOCUMENTS WERE PREPARED OR APPROVED BY ME, AND THAT I AM A DULY LICENSED PROFESSIONAL ENGINEER UNDER THE LAWS OF THE STATE OF MARYLAND.

LICENSE NO: 37247

EXPIRATION DATE: 01/09/2024

NO.	DESCRIPTION	DATE


KEY PLAI


EXISTING AIRFLOW PLANS

OJECT NUMBER	PO-10028674
TE	05/25/2023
AWN BY	ВМВ
ECKED BY	SRH


M203

21/2018 3:54 PM

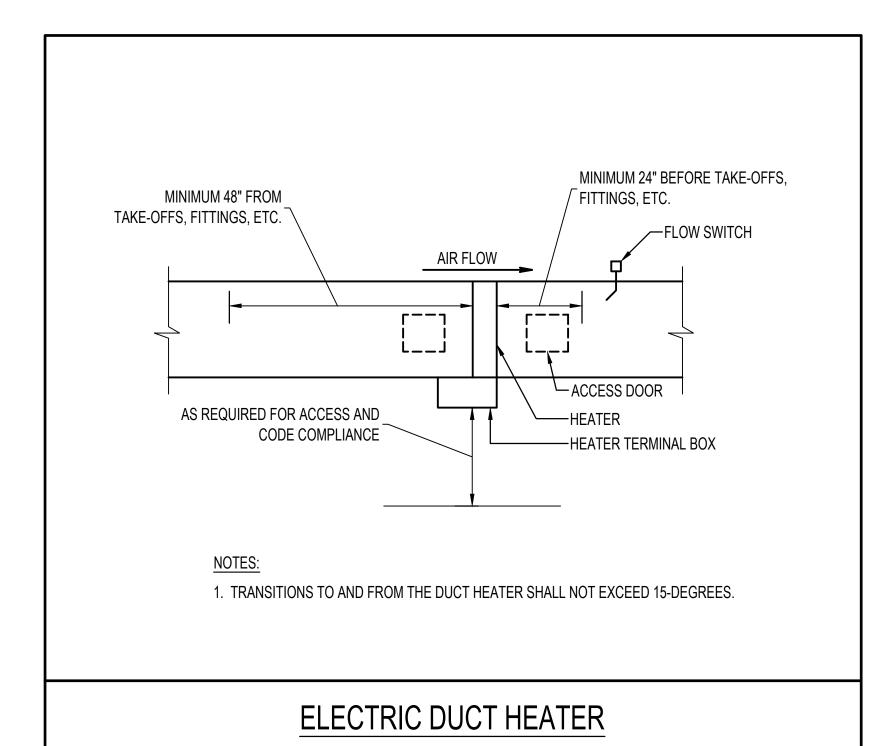


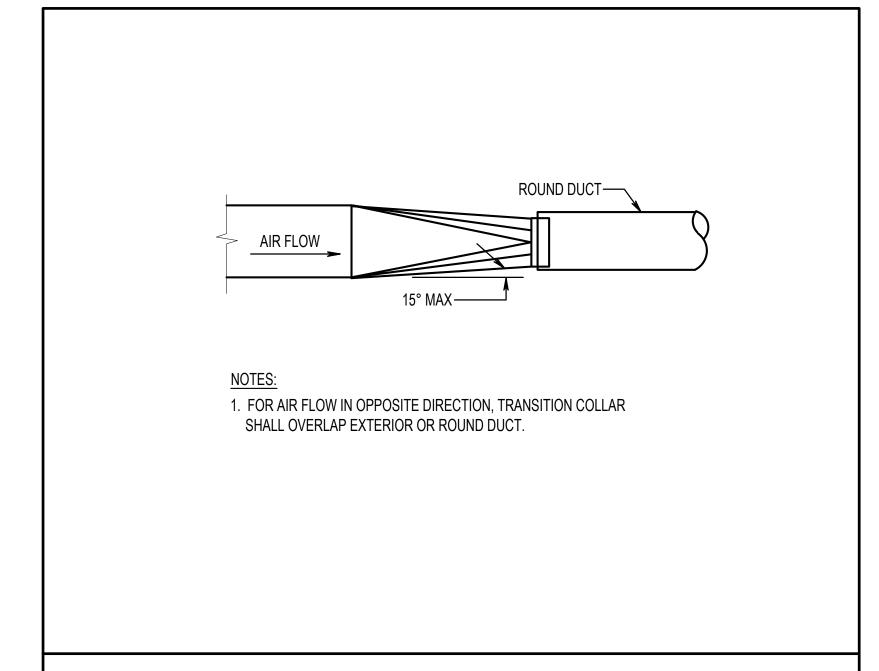



RECTANGULAR TO ROUND DUCT TRANSITION

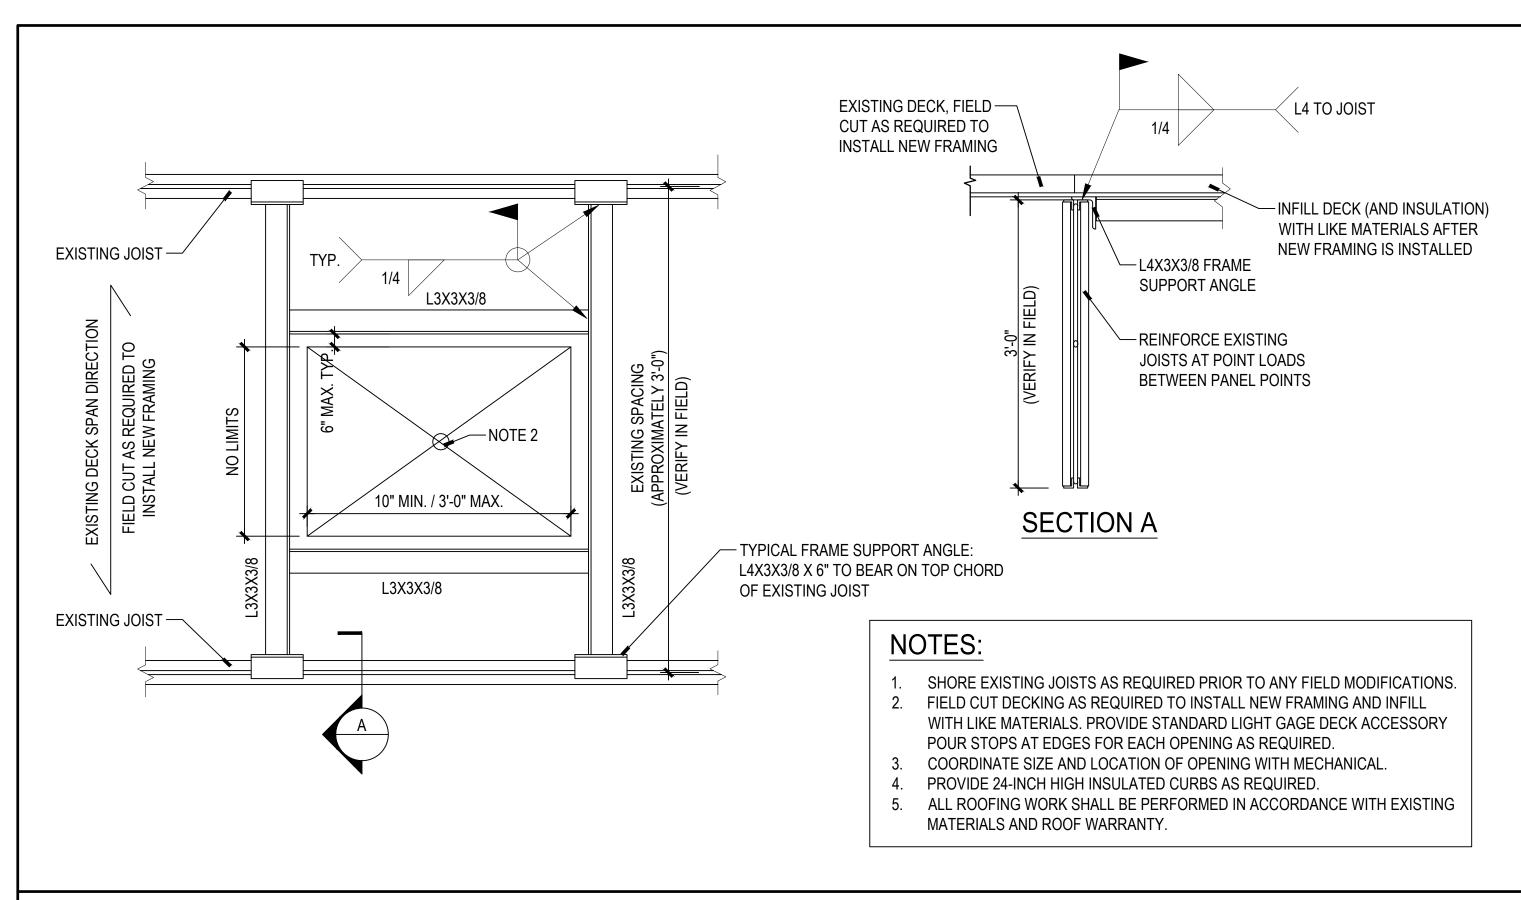


ANGLE SUPPORT FRAME AT ROOF DECK - GLENELG HIGH SCHOOL

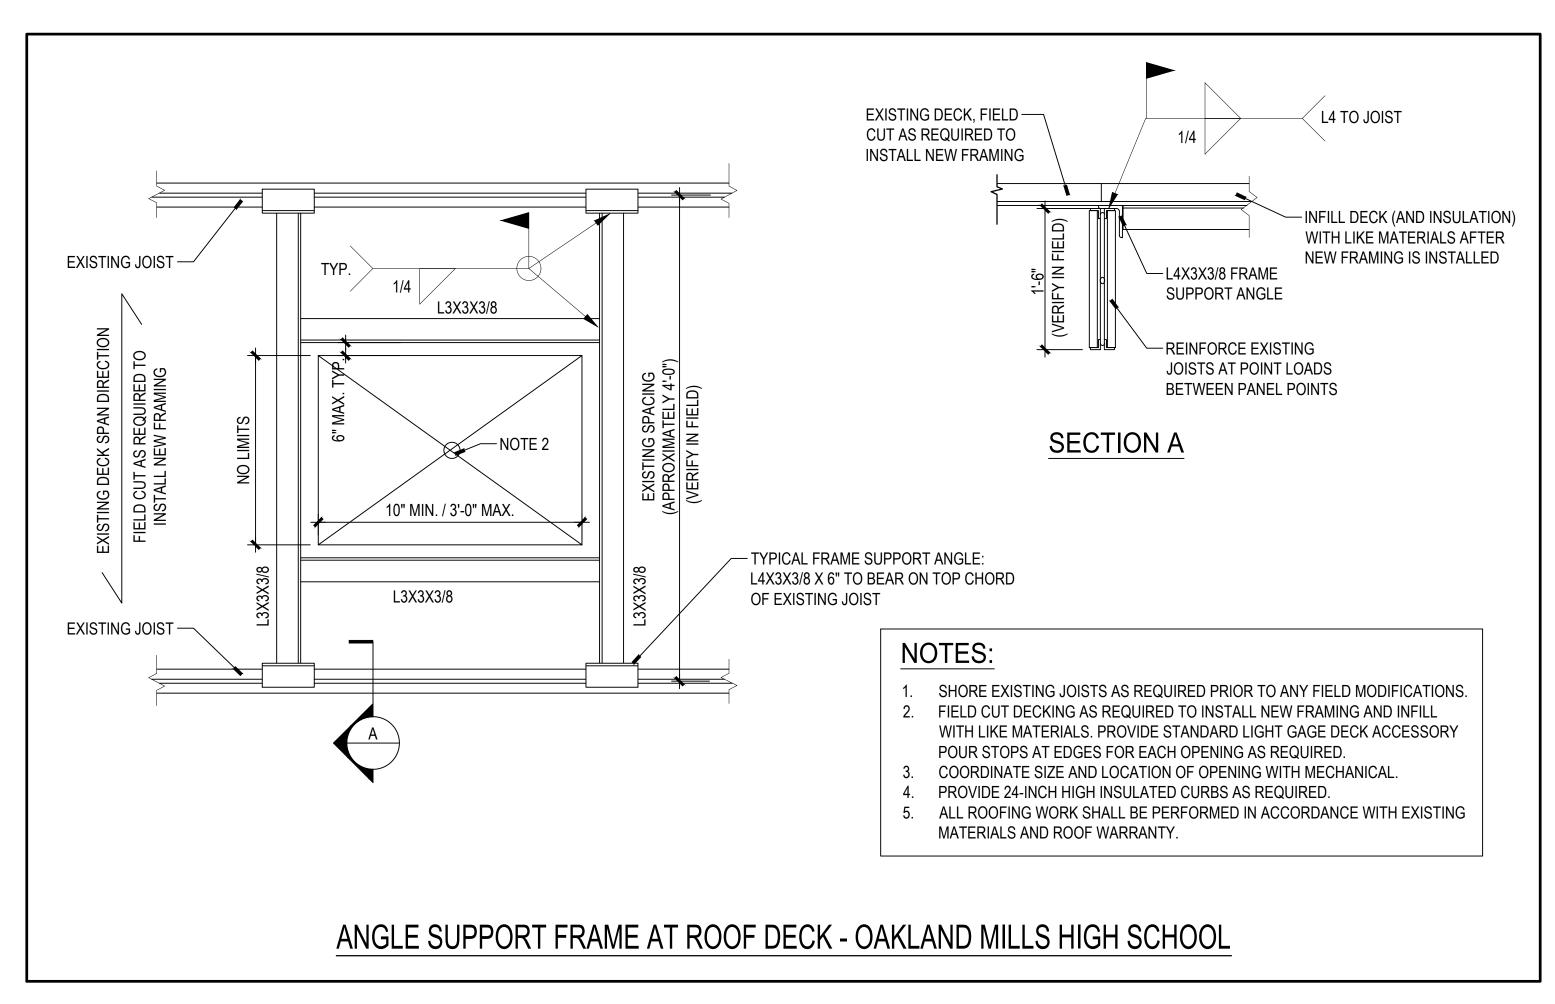

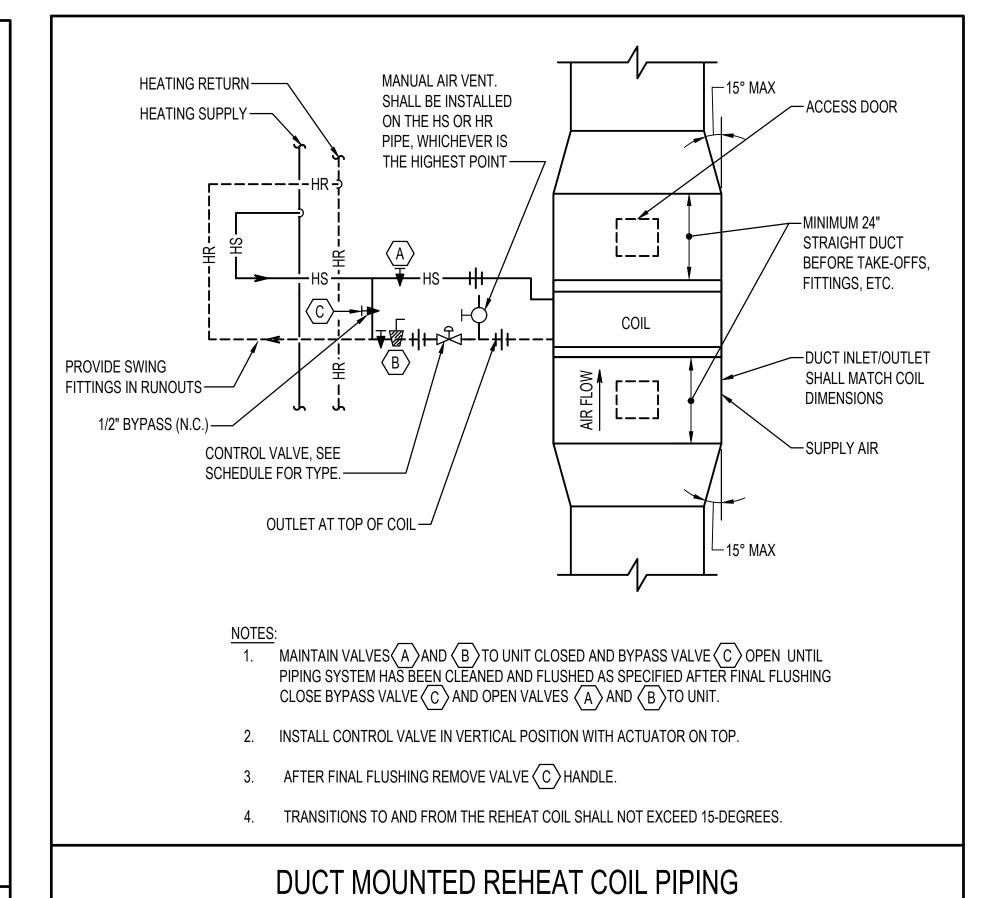

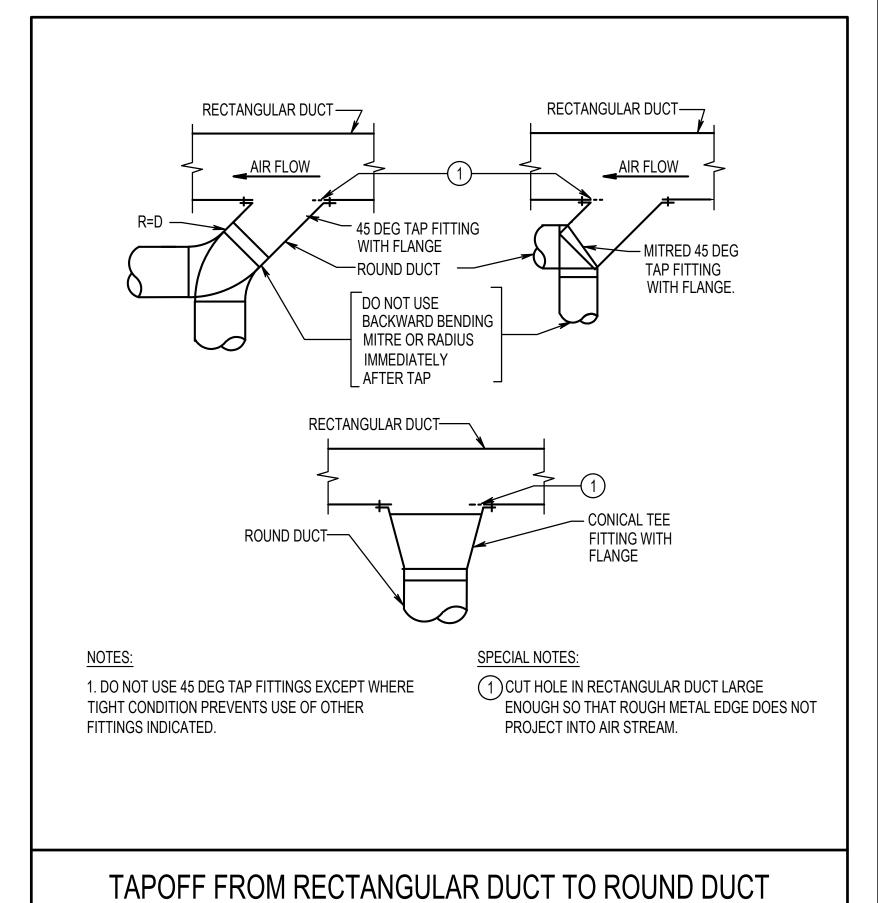

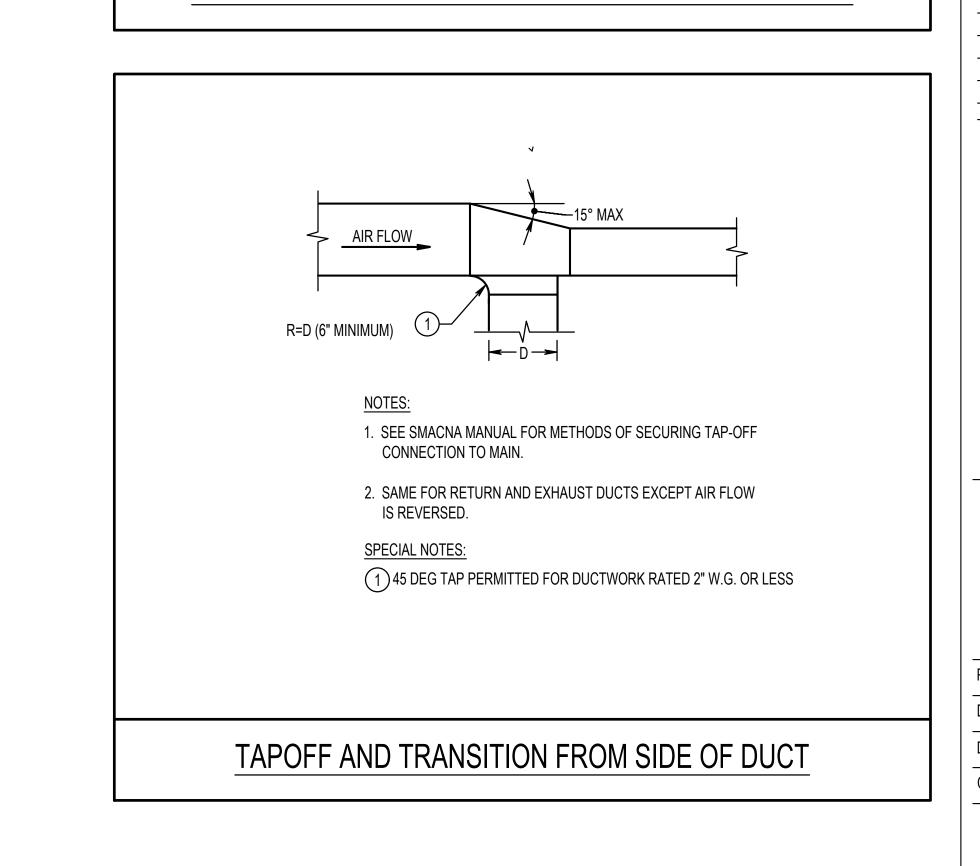





MECHANICAL ELECTRICAL & PLUMBING ENGINEERS MEP ENGINEERING

HENRY ADAMS,LLC 600 BALTIMORE AVENUE SUITE 400 BALTIMORE, MD 21204 (410) 296-6500

PROJECT

HOWARD COUNTY PUBLIC SCHOOLS

CAFETERIA HVAC UNIT CONVERSIONS

CONSTRUCTION DOCUMENTS

PROFESSIONAL CERTIFICATION: I HEREBY CERTIFY THAT THESE DOCUMENTS WERE PREPARED OR APPROVED BY ME, AND THAT I AM A DULY LICENSED PROFESSIONAL

LICENSE NO: 37247 EXPIRATION DATE: 01/09/2024

> DESCRIPTION DATE

KEY PLAN

MECHANICAL DETAILS

PROJECT NUMBER PO-10028674 DATE 05/25/2023 DRAWN BY CHECKED BY